dys architecture

260 - 1770 Burrard Street Vancouver BC V6J 3G7 tel 604.669.7710 www.dysarchitecture.com

EXTERIOR MATERIAL/ FINISH LEGEND PREFINISHED METAL PANEL - WHITE PERFORATED METAL SCREEN (3) PRE-FINSHED METAL PANEL - 6/REY 4 WOOD GRAIN SOFFIT (5) WOOD-LIKE PRIVACY SCREEN ALUMINUM WINDOW PRAME - CHARCOAL 1 ALIMINUM WINDOW FRAME - GREY (8) SPANDREL PANEL - CHARCOAL SPANDREL PANEL - WOOD GRAIN (9) SPANDREL GLASS - GREY PAINTED STEEL STRUCTURE - CHARCOAL (2) BRICK - EARTH TONE BROWN B PRE-FINSHED ALUMINUM & CLEAR GLASS GUARDRAIL (4) METAL CLADDING - WOOD TONE VARIOUS COLOURS (6) GLULAM CANOPY STRUCTURE WITH GLASS

(6) HEAVY TIMBER (APPROX, 8"X12")

(5) II) I5) 6) I6) 8) 4) (3) (1) (7) (0) (1) (3) (3) (12) T.O. MECHANICAL PARAPET WS ROOF SLAB 124'-6" IIO'-6' IVS ROOF SLAB (q1'-6") 6 LEVEL 1 81'-8' F LEVEL 6 MARINE DRIVE (TI'-10') (62'-0" 10'-2" P2

PROJECT

EXECUTIVE PARC MARINE+TAYLOR RESIDENTIAL

657 Marine Drive West Vancouver BC

ELEVATION EAST (6TH STREET)


PROJECT A215294

DRAWN JL/SS CHECKED NC

SCALE 1/16"=1'-0" DATE NOV. 19. 2018

EXTERIOR MATERIAL/ FINISH LEGEND PREFINISHED METAL PANEL - WHITE 2 PERFORATED METAL SCREEN (3) PRE-FINSHED METAL PANEL - 6/REY (4) WOOD GRAIN SOFFIT (5) WOOD-LIKE PRIVACY SCREEN 6 ALUMINUM WINDOW FRAME - CHARCOAL ALIMINUM WINDOW FRAME - GREY (8) SPANDREL PANEL - CHARCOAL SPANDREL PANEL - WOOD GRAIN (9) SPANDREL GLASS - GREY PAINTED STEEL STRUCTURE - CHARCOAL (2) BRICK - EARTH TONE BROWN B PRE-FINSHED ALUMINUM & CLEAR GLASS GUARDRAIL (4) METAL CLADDING - WOOD TONE VARIOUS COLOURS (6) GLULAM CANOPY STRUCTURE WITH GLASS

(6) HEAVY TIMBER (APPROX, 8"X12")

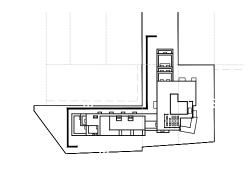


dys architecture 260 - 1770 Burrard Street Vancouver BC V6J 3G7 tel 604.669.7710 www.dysarchitecture.com



NO. | DATE | ISSUE

- 01 | 2018.05.17 | ISSUED FOR DRC 02 | 2018.11.19 | ISSUED FOR PCM
- 03 2019.03.28 RESPONSE TO MEMORANDUM

NO. | DATE | REVISION

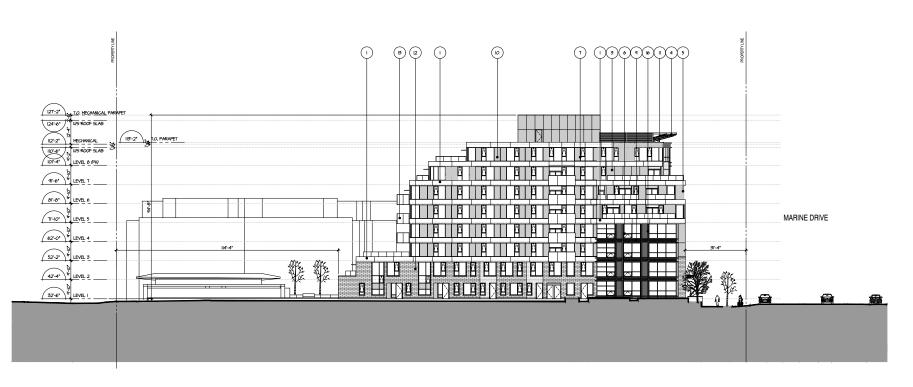

PROJECT

EXECUTIVE PARC MARINE+TAYLOR RESIDENTIAL

657 Marine Drive West Vancouver BC

ELEVATION WEST

PROJECT A215294

DRAWN JL/SS CHECKED NC


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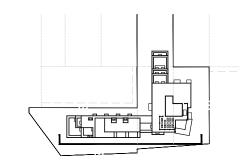
PROJECT A215294

DRAWN JL/SS CHECKED NC

SCALE 1/16"=1"-0"

DATE NOV. 19, 2018



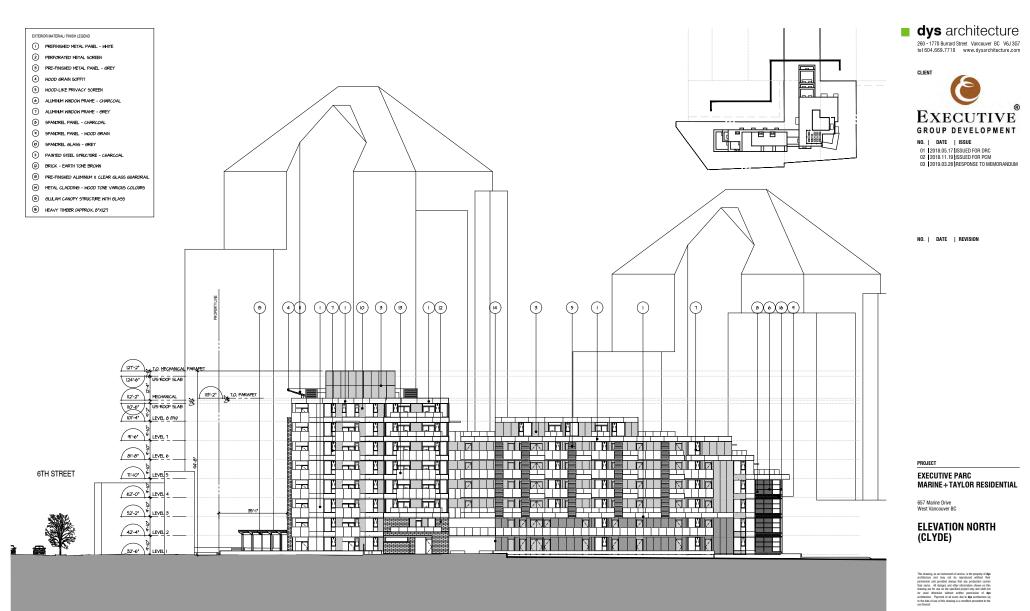



NO. | DATE | ISSUE

01 2018.05.17 ISSUED FOR DRC 02 2018.11.19 ISSUED FOR PCM

03 2019.03.28 RESPONSE TO MEMORANDUM

NO. | DATE | REVISION



PROJECT

EXECUTIVE PARC MARINE+TAYLOR RESIDENTIAL


657 Marine Drive West Vancouver BC

ELEVATION SOUTH (MARINE)

COLOUR ELEVATION

PROJECT A215294 DRAWN JL/SS CHECKED NC

SCALE 1/16"=1'-0" DATE NOV. 19. 2018

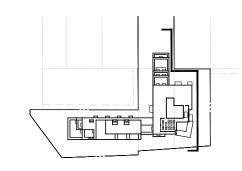



NO. | DATE | ISSUE 01 | 2018.05.17 | ISSUED FOR DRC 02 | 2018.11.19 | ISSUED FOR PCM 03 | 2019.03.28 | RESPONSE TO MEMORANDUM

NO. | DATE | REVISION



PROJECT

EXECUTIVE PARC MARINE+TAYLOR RESIDENTIAL

657 Marine Drive West Vancouver BC


ELEVATION EAST (6TH STREET)

COLOUR ELEVATION

PROJECT A215294

SCALE 1/16"=1'-0" DATE NOV. 19. 2018

DRAWN JL/SS CHECKED NC

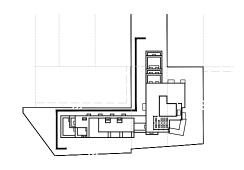

GROUP DEVELOPMENT

NO. | DATE | ISSUE 01 | 2018.05.17 | ISSUED FOR DRC 02 | 2018.11.19 | ISSUED FOR PCM 03 | 2019.03.28 | RESPONSE TO MEMORANDUM

NO. | DATE | REVISION



PROJECT

EXECUTIVE PARC MARINE+TAYLOR RESIDENTIAL

657 Marine Drive West Vancouver BC

ELEVATION WEST

COLOUR ELEVATION

PROJECT A215294


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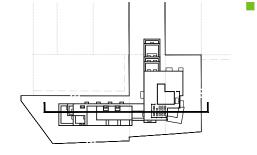
SCALE 1/16"=1'-0" DATE NOV. 19. 2018

PLOT STAMP: 2019-Mar-28 @10:54am - P:\A215294 - Executive Group - Park Royal Site\CAD\SD\A215294_elev.dwg - A3.07

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DRAWN JL/SS CHECKED NC SCALE 1/16"=1'-0" DATE NOV. 19. 2018





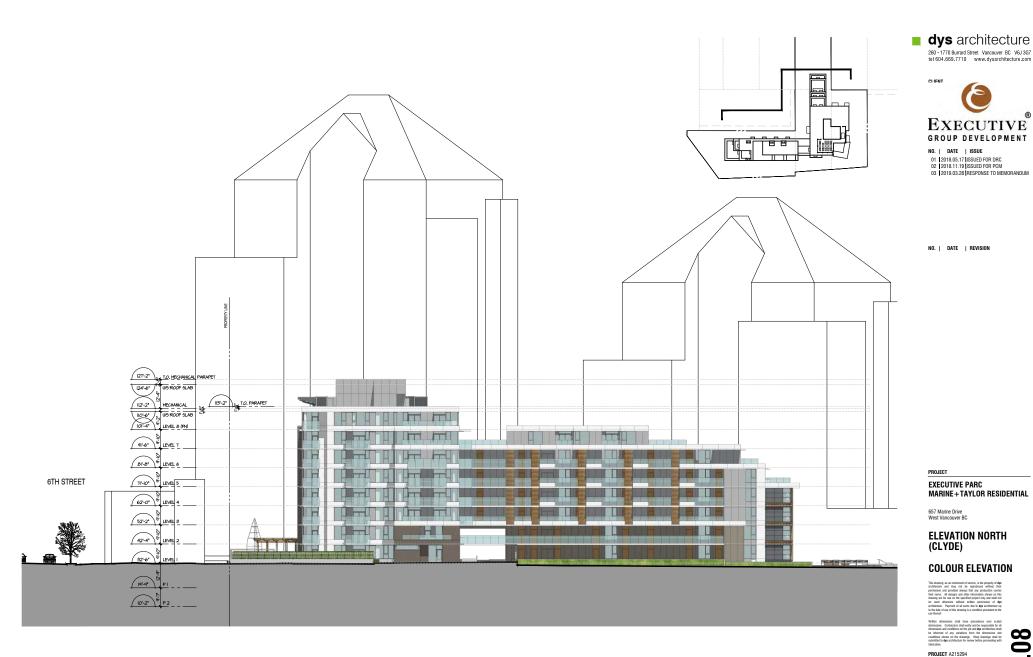

NO. | DATE | ISSUE

01 2018.05.17 ISSUED FOR DRC 02 2018.11.19 ISSUED FOR PCM

03 | 2019.03.28 | RESPONSE TO MEMORANDUM

NO. | DATE | REVISION

PROJECT

EXECUTIVE PARC
MARINE + TAYLOR RESIDENTIAL

657 Marine Drive
West Vancouver BC

SECTION B-B

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see trainers.


Within dimensions shall have precedence over a dimensions. Contractors shall verify and be responsible it dimensions and conditions on the job and dips architecture be informed of any variables from the dimensions conditions shown on the drawings. Stop drawings sh

PROJECT A215294

PROJECT A215294
DRAWN JL/SS CHECKED NC

SCALE 1/16"=1'-0" DATE NOV. 19, 2018



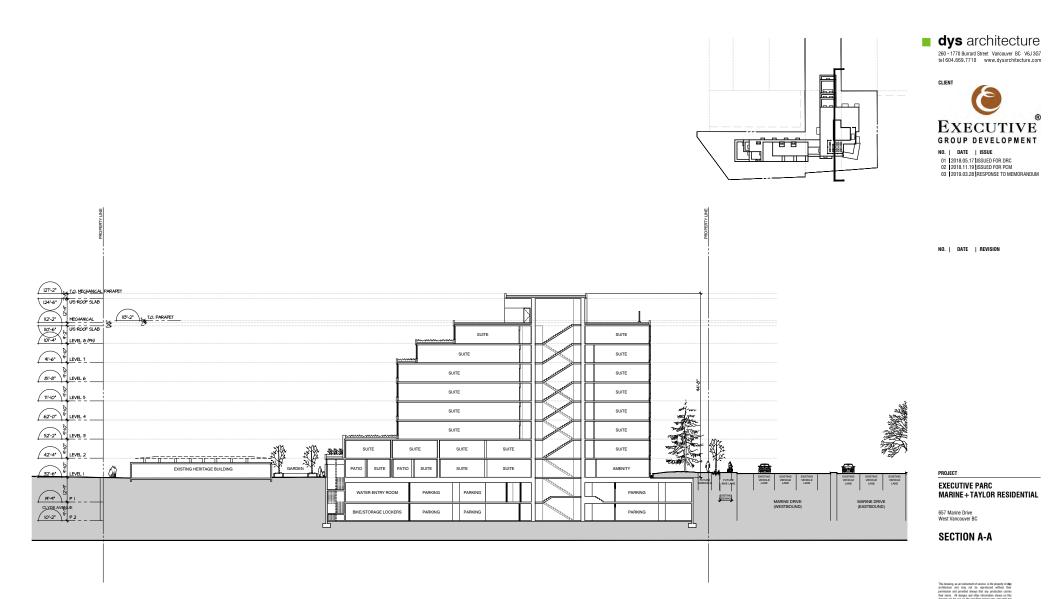


PROJECT A215294


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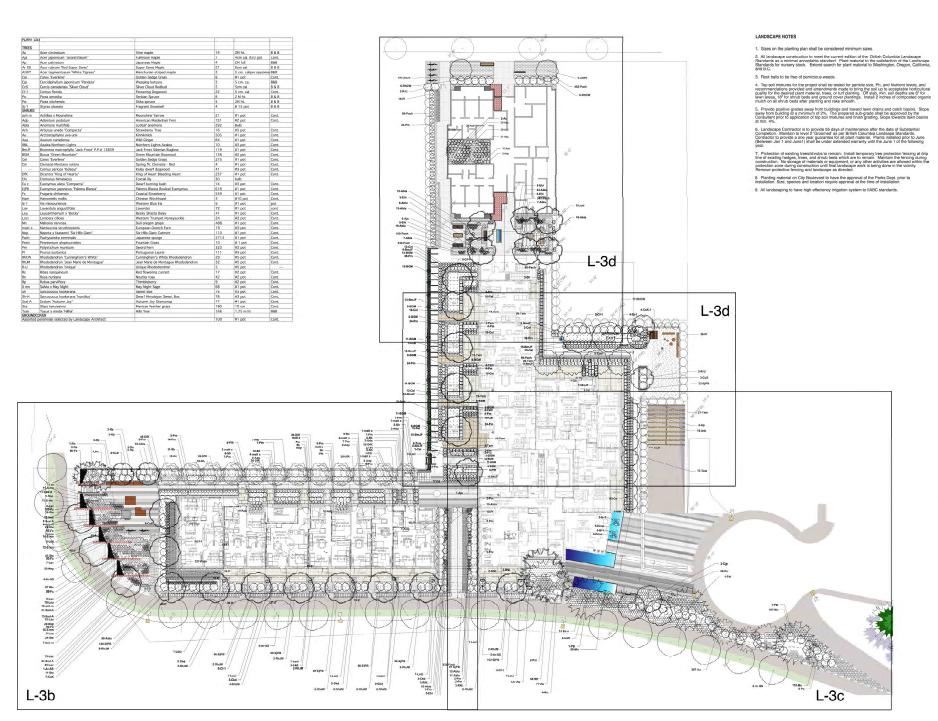
SCALE 1/16"=1'-0" DATE NOV. 19. 2018





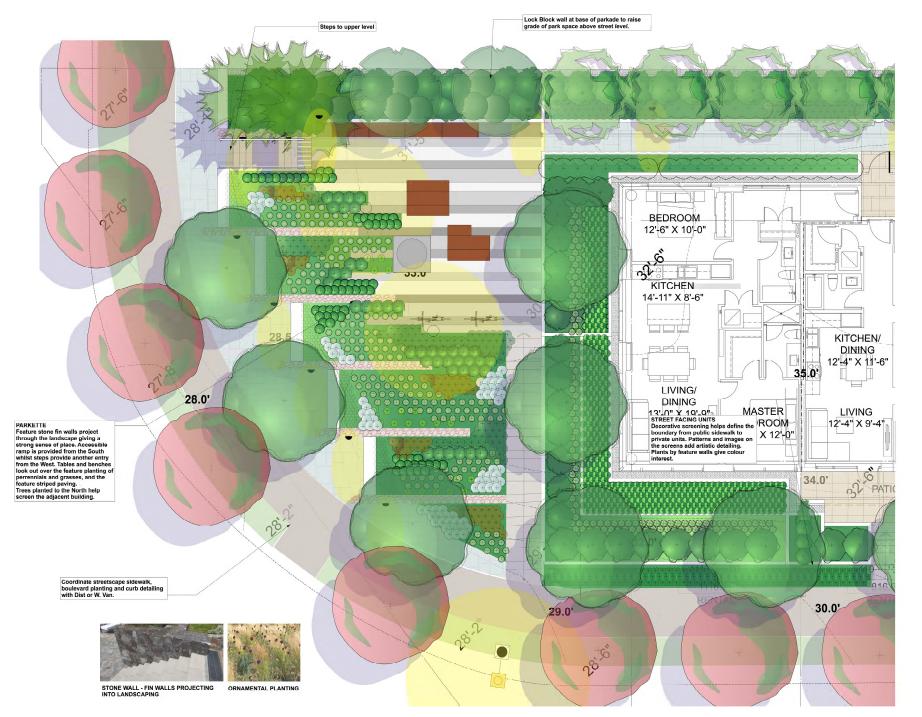




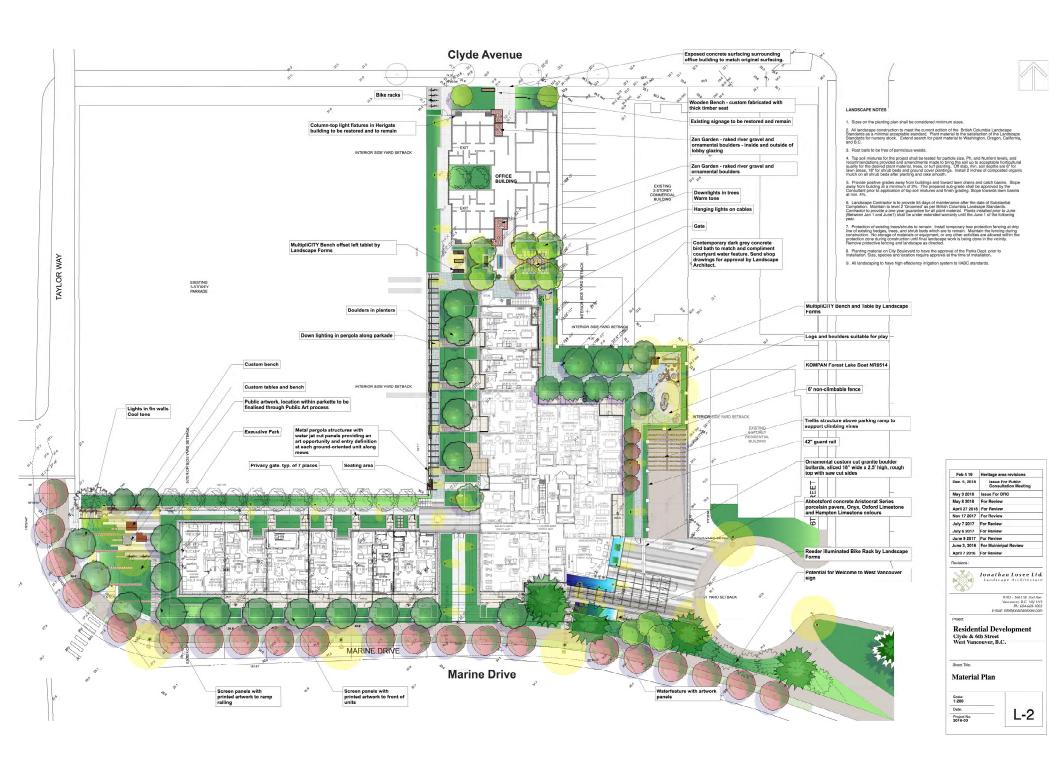








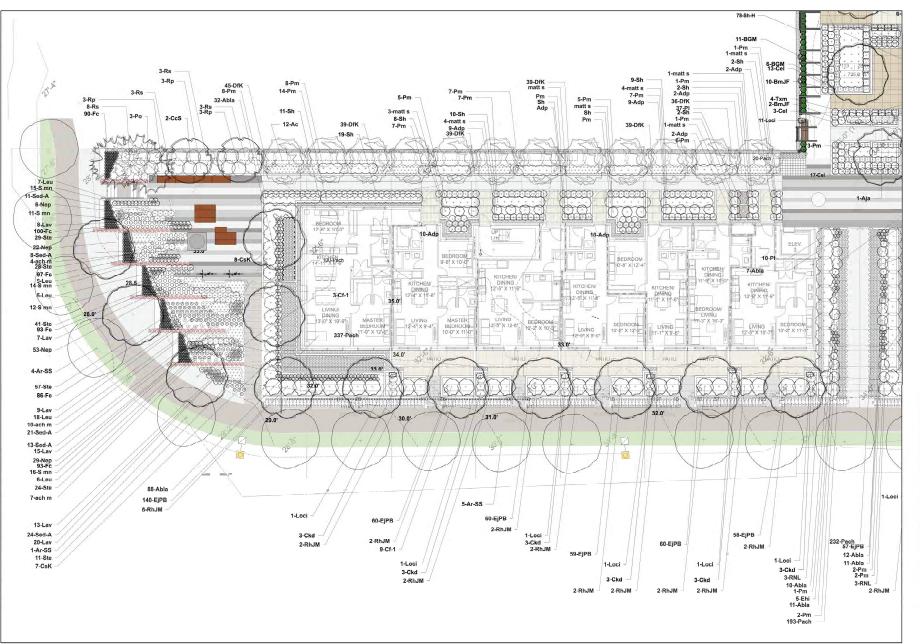




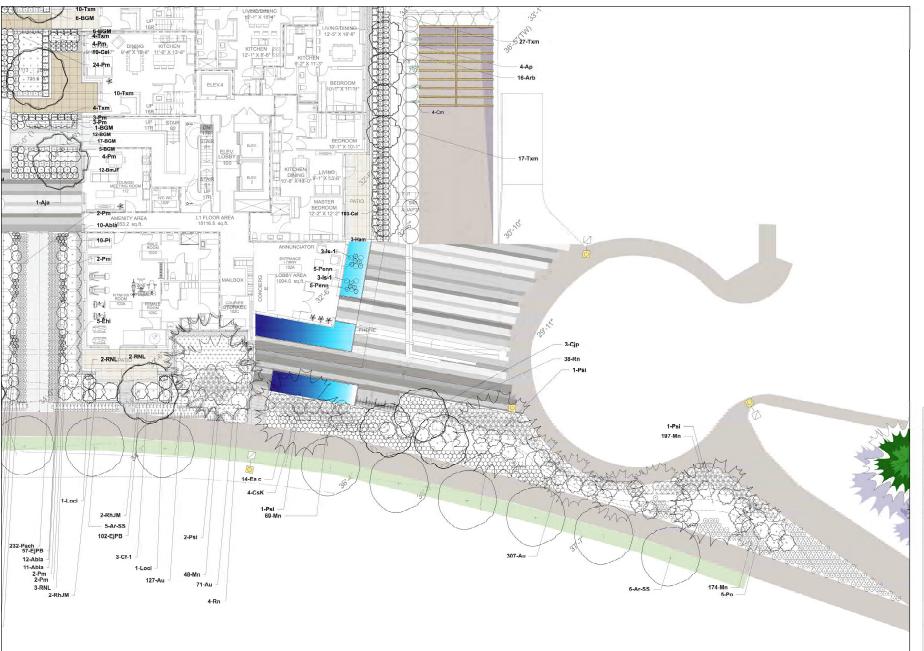







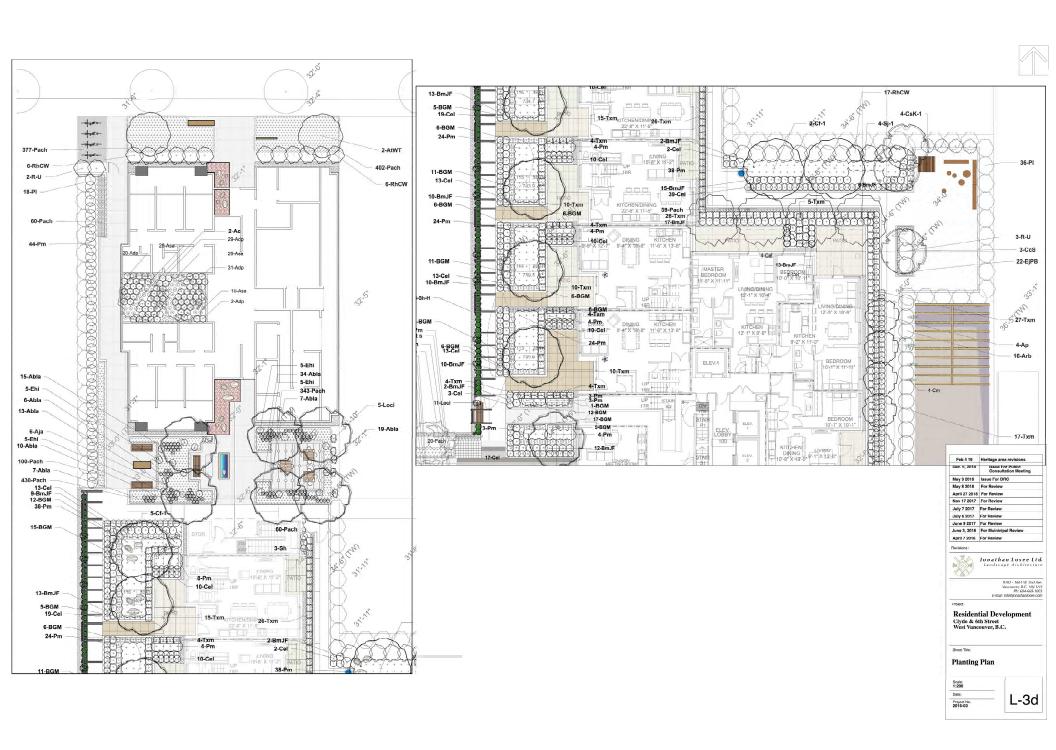





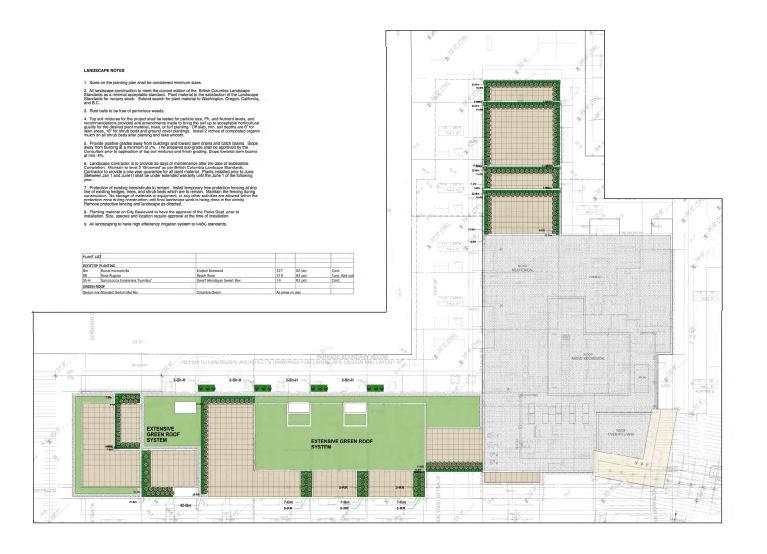




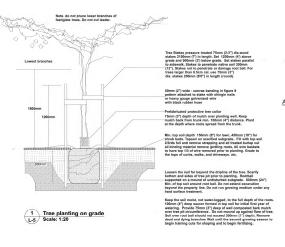

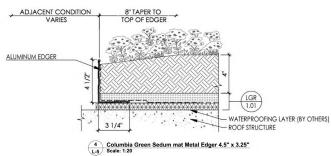


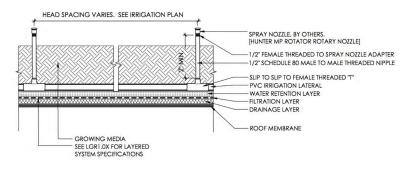

Columbia Green Sedum mat Spray Irrigation L-5 Scale: 1:20

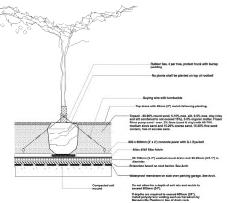



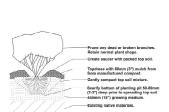


NOTES:

1. Min. container size and root spread to BCSLA/BCNTA landscape standards for Nursery Stock - current edition.

2. Prune all damaged, diseased, or weak limbs and roots.

3. Do not allow roots to dry out during installation process, water plant roots well pror to planting and water immediately following planting.




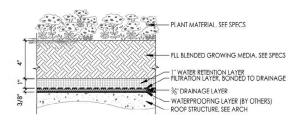


NOTE:


1. SYSTEM COMPONENTS ARE SHOWN AT NOMINAL SIZE, COMPRESSION WILL
OCCUR AT RETENTION LAYER BASED ON AMOUNT (HEIGHT/VOLUME) OF
GROWING MEDIA PLACED ON SYSTEM. MAXIMUM COMPRESSION ½" ±.



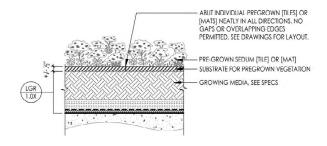


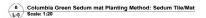




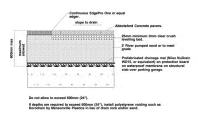





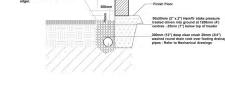




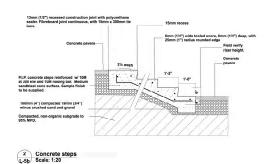

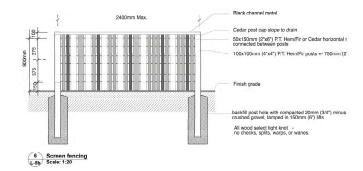


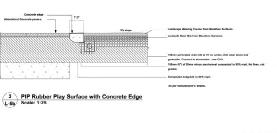


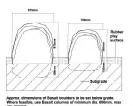

Approx. dimensions of Basalt boulders to be set below grade. Where feasible, use Basalt columns of minimum dia. 600mm. max dia. 900mm. Smeeth all jegged edges to the satisfaction of the landscape architect.

Boulders in play area Scale: 1:25

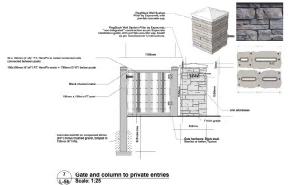

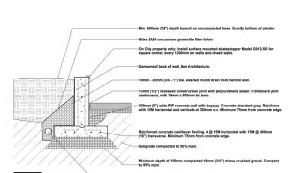


C/w solid metal pin 3/8" dia.

Handrail 41mm (1-5/8") diameter HSS handrail - both ends capped with half spheres and ground smooth. Textured tactile warning strip at top and bottom of handrail.

Handraii 41 mm (1-5/8") diameter HSS pipe to be fit over steel post secured into footing and then welded on site. Provide clearance btwn handrail and any wall -50mm (2") for smooth surface and 63mm (2.5") for rough surface.

-Steel anchor post with 100mm x 100mm (4° x 4°) metal base plate sized to fit inside diameter of handrail post.

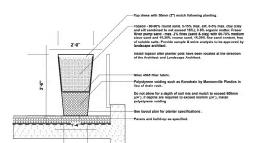




8 Handrails to steps L-5b Scale: 1:20

9 Concrete retaining wall Scale: 1:20





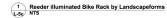



3 MultipliCITY Bench and Table by Landscape Forms or equal L-5c NTS



5 Bollard Light GEORGE by Rotorgroup or approved equivalent L-5g NTS



7 Boca 613 in-wall light L-5c NTS



8 Custom wood and metal bench in parkette
L-5c NTS



Compan Forest Lake Boat NR0514 NTS




(6) Cambria 213 by Lumec in trees and overhead wires
L-5c) NTS




 $\left(\begin{array}{c} \overline{9} \\ \underline{\text{L-Sg}} \end{array} \right)$ Custom wood and metal table and bench in parkette



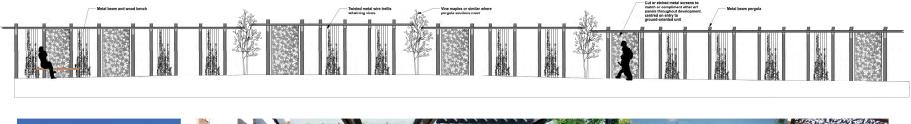



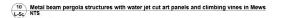





EXECUTIVE PARC
MARINE+TAYLOR RESIDENTIAL 657 Marine Drive - West Vancouver BC

NORTH SHORE ADVISORY COMMITTEE ON DISABILITY ISSUES

EXECUTIVE GROUP DEVELOPMENT ■ dys architecture

No. A215294 RESPONSE TO MEMO - MARCH 28, 2019



February 25, 2019

Lisa Berg Senior Community Planner District of West Vancouver 750 17th Street, West Vancouver V7V 3T3

Re: Response to the Advisory Committee on Disability Issues Recommendations – 657 & 675 Marine Drive and 660 Clyde Avenue

Dear Lisa,

In response to the Advisory Committee on Disability Issues (ACDI) Development and Inclusion Report, dated July 26, 2018, and the subsequent comments that were provided via email on November 22, 2018, Executive Park Limited Partnership summarizes below to undertake and incorporate these ACDI recommendations:

Tower:

- Automatic door openers will be added will be added at the following locations:
 - o P2 P202 3 vestibule doors
 - o P1 Garbage Room, P102 Vestibule 2 doors, Commercial access to Elevator 3
 - L1 Main Entry Vestibule 2 doors, Aperture Entrance, Fitness Room, Lounge, H/C WC, Lobby Door to Units 117/118
- Room numbers and titles for amenities will be displayed with clear fonts, with a sufficiently large size and with good contrast
- A visual alarm system will be installed at minimum to compliment all the locations where automatic door openers will be added
- Mail box recommendations that they be made available at a lowered level and to have tactile raised letters/numbers with high contrast will be taken to Canada Post for review and approval, and will be incorporated consistent with Canada Post mail box guidelines

Adaptable Units:

- The accessible parking spaces will be matched to adaptable units
 - o P2 Stalls 43 & 49
- Parking spaces whose location provides additional space for loading, but do not meet the
 width requirements will be designated as "accessible" and will be referenced as
 "adaptable". These adaptable parking spaces will be matched to adaptable units
 - o P2 Stalls 37, 51, 52, 80, 86 & 89
 - o P1 Stalls 28 & 33

- The adaptable units with balconies are proposed to have level access by way of a swing door.
 - o Units 218, 318, 418, 518, 618 & 718
- The provision will be made for retractable cabinet doors at sink locations
- The provision will be made for side opening wall ovens with a pull out board underneath, provided a comparable unit to the marketed design appliances is available
- The provision will be made for 8 units to have side-by-side front loading washers and dryers, as the current layouts will not be significantly altered
 - o Rental Units 109 & 209
 - o Market Units 101, 203, 303, 403, 503 & 603
- There are no pocket doors presently proposed in the adaptable units no provisions need to be made for pocket door hardware
- The provision will be made to rough in for a double drain, where required, to accommodate for any future conversions

Elevators:

• Automated floor verbal announcements will be installed in all the elevators

Public Realm:

- Tactile Walking Surface Indicators (TWSI) will be added at the top and bottom of the
 exterior stairs, colour to be coordinated with the District's standard specification
- At the 1 accessible public washroom, and the 2 Fitness Room change rooms, the most accessible hand dryers (Dyson), soap dispensers (automated), faucets (automated) and toilet flush options (handle) will be incorporated
- Gym to incorporate roll in showers, and if required, with a collapsible water dam
- A curb detail will be incorporated at the water features
- The play area surface treatment will allow for wheelchair and walker access
- Curb cut treatments will be incorporated as noted to comply with the City of Vancouver standards, unless superseded by a District of West Vancouver standard

We appreciate the input and recommendations provided by the Advisory Committee on Disability Issues, as they will enhance the overall development.


Regards,


Greg Santa

Development Manager

8TH FLOOR, 1080 HOWE STREET, VANCOUVER, BC CANADA V6Z 2T1 TEL: 604 642 5252 FAX: 604 642 5255 WWW.EXECUTIVEGROUPDEVELOPMENT.COM



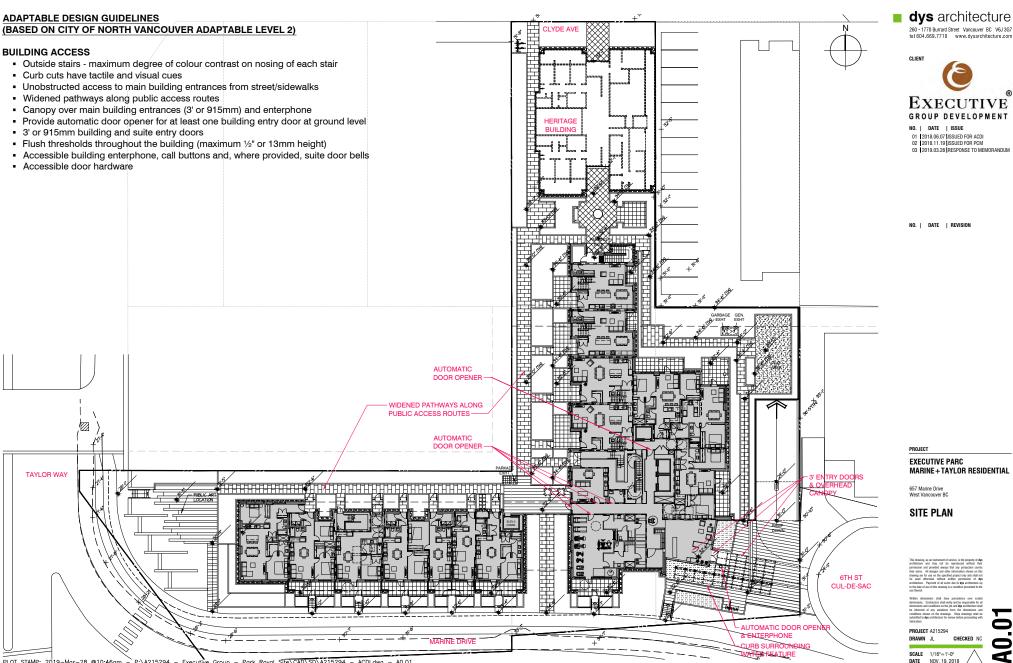

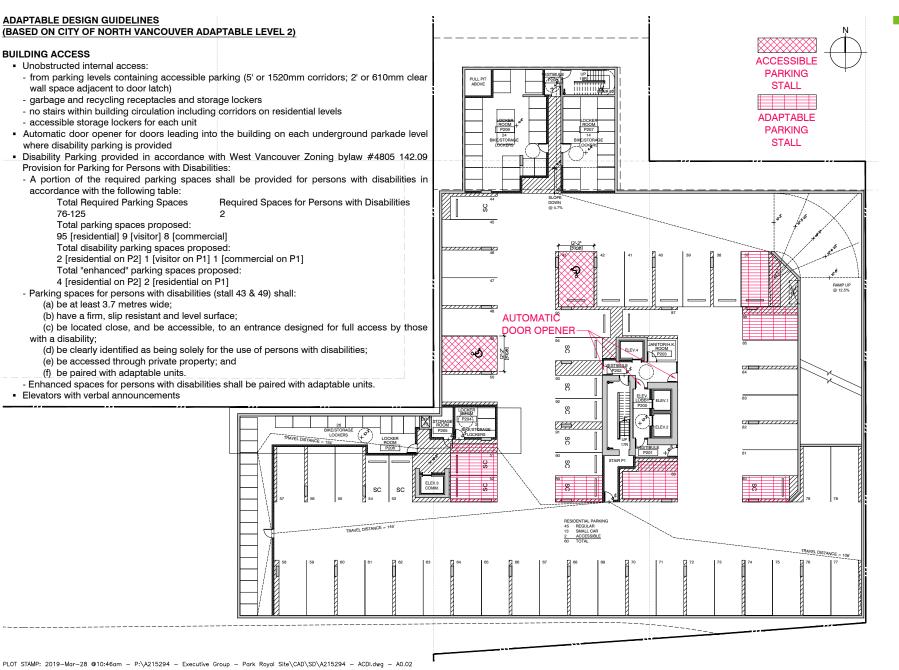



NO. | DATE | ISSUE

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03 12019.03.28 IRESPONSE TO MEMORANDUM

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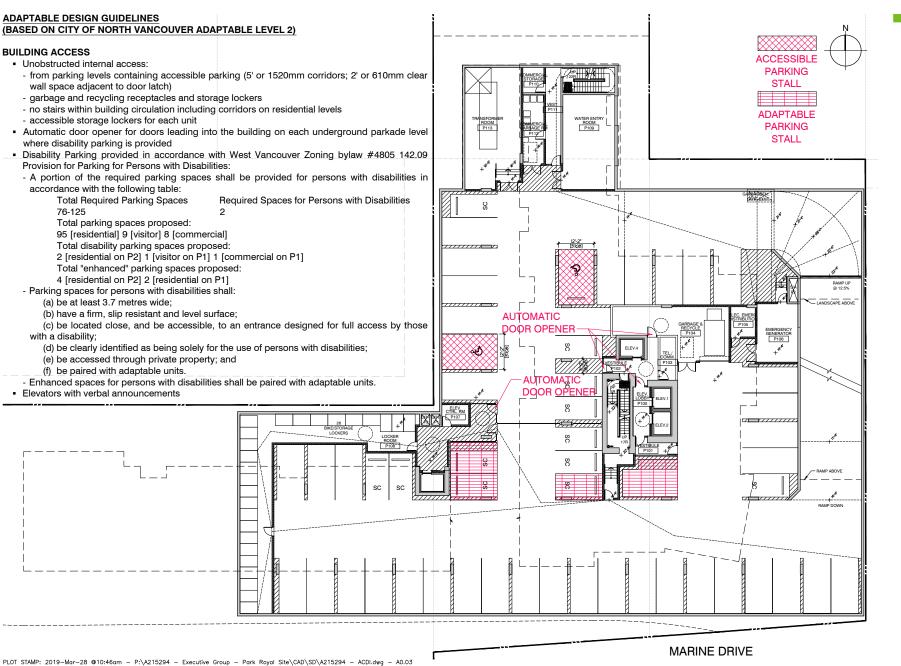
EXECUTIVE PARC MARINE+TAYLOR RESIDENTIAL

657 Marine Drive West Vancouver BC

PARKING PLAN LEVEL P2

PROJECT A215294 DRAWN JL

SCALE 3/32"=1'-0"



dys architecture



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657 Marine Drive West Vancouver BC


PARKING PLAN LEVEL P1

PROJECT A215294

DRAWN JL

SCALE 3/32"=1'-0" DATE NOV. 19, 2018

DATE NOV. 19. 2018

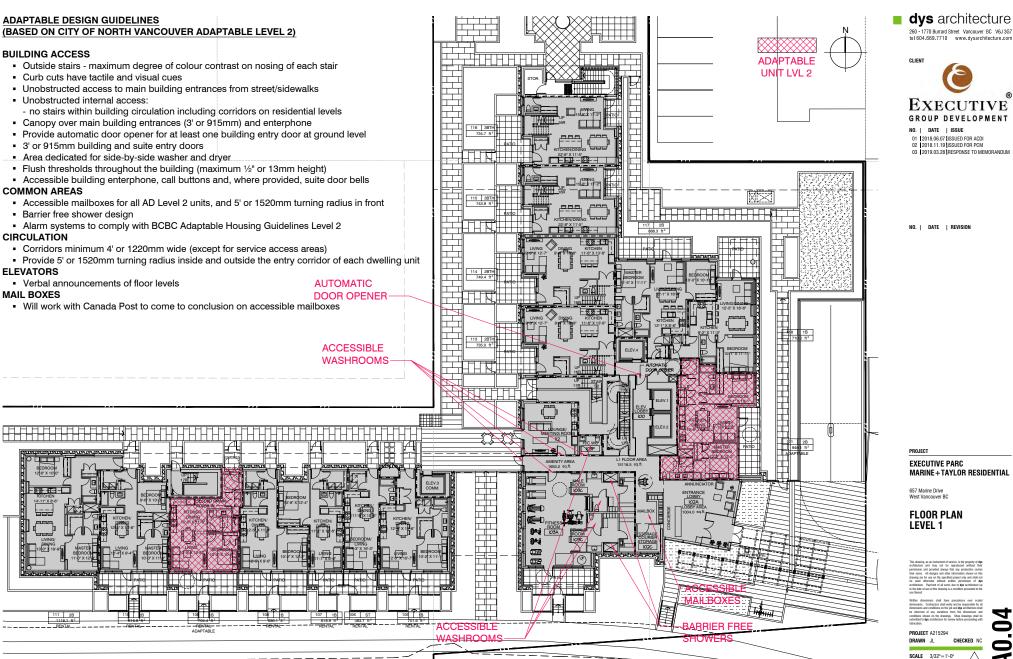

PROJECT

FLOOR PLAN LEVEL 2

SCALE 3/32"=1'-0"

DATE NOV. 19, 2018

ADAPTABLE DESIGN GUIDELINES (BASED ON CITY OF NORTH VANCOUVER ADAPTABLE LEVEL 2) **BUILDING ACCESS**

- Unobstructed internal access:
- no stairs within building circulation including corridors on residential levels
- 3' or 915mm building and suite entry doors
- Flush thresholds throughout the building (maximum ½" or 13mm height)

CIRCULATION

- Corridors minimum 4' or 1220mm wide (except for service access areas)
- Provide 5' or 1520mm turning radius inside and outside the entry corridor of each dwelling unit

SUITE CIRCULATION

- Provide wiring for an automatic door opener for the suite entry door
- Provide 2' or 610mm clear wall space adjacent to door latches where door swings toward user (pocket doors acceptable for bathrooms and bedrooms)
- Floor area for side-by-side washer-dryer accommodated in multiple suites

DOORS

• Minimum one bathroom, minimum one bedroom and storage room doors 2'-10" or 860mm clear opening

PATIOS & BALCONIES

- Minimum one door 2' 10" or 860mm clear door opening
- Minimum one patio or balcony doorsill with maximum ½" or 13mm threshold
- Minimum 5' or 1520mm turning radius on patio /balcony
- Adaptable units to have level slabs for universal access to suite patios & balconies

WINDOWS

- Opening mechanism maximum 46" or 1168mm above floor (provide notation on window
- Provide minimum 6-0' or 1800mm horizontal windows in living room, dining room and minimum one bedroom where sills are not more than 2'- 6" or 750mm above the floor

KITCHEN

- Continuous counter between sink and stove
- Retractable cabinet doors to be considered in unit design

MIN. ONE BATHROOM

- Toilet located adjacent to wall (min 3' or 915mm length)
- Provide turning radius within bathroom (may result from removal of vanity cabinet)
- 3' or 915mm clearance along full length of tub
- Tub control valve placed at outer edge of tub, with tub spout remaining in central position



116 UPPER 843.4 ft²

115 UPPER 812.6 ft²

114 UPPER 746.8 ft²

113 UPPER 744.4 ft²

212 1B 684.8 ft²

UNIT LVL 2

NO. | DATE | REVISION

NO. | DATE | ISSUE

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657 Marine Drive West Vancouver BC

PROJECT A215294

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PROJECT **EXECUTIVE PARC** MARINE+TAYLOR RESIDENTIAL


657 Marine Drive West Vancouver BC FLOOR PLAN LEVEL 3


PROJECT A215294 SCALE 3/32"=1'-0"

DATE NOV. 19, 2018

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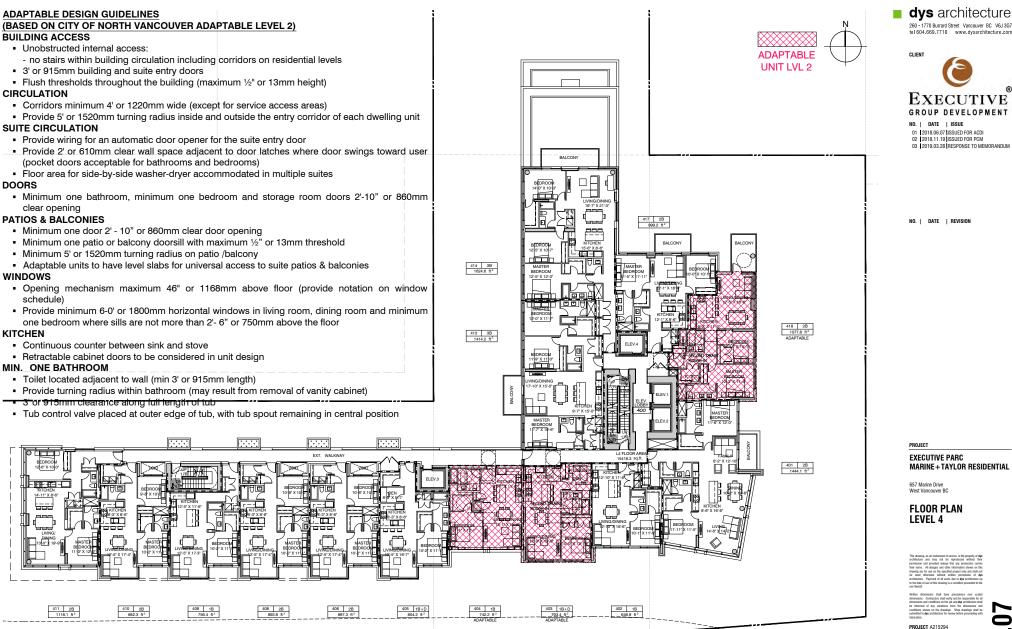
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ADAPTABLE DESIGN GUIDELINES

SCALE 3/32"=1'-0" DATE NOV. 19. 2018

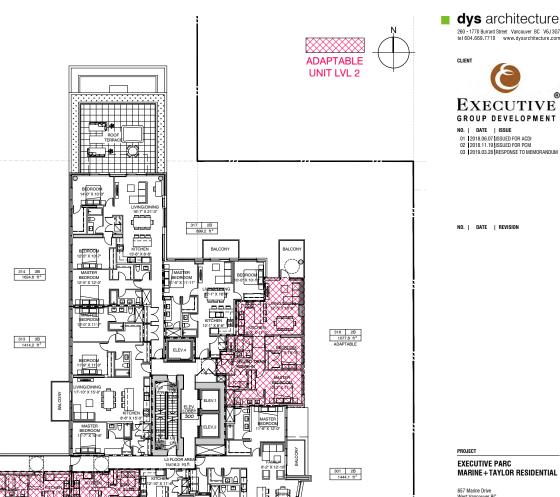

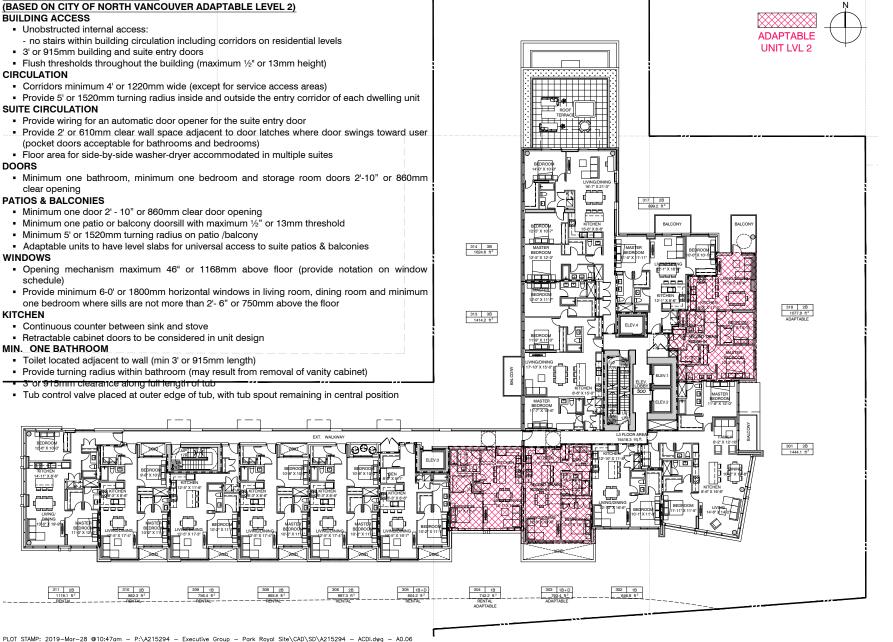



NO. | DATE | ISSUE

UNIT LVL 2

- 01 | 2018.06.07 | ISSUED FOR ACDI
- 03 2019.03.28 RESPONSE TO MEMORANDUM

NO. | DATE | REVISION

PROJECT

EXECUTIVE PARC MARINE+TAYLOR RESIDENTIAL

657 Marine Drive West Vancouver BC

FLOOR PLAN LEVEL 5

DATE NOV. 19, 2018

PROJECT A215294

SCALE 3/32"=1'-0"

ADAPTABLE DESIGN GUIDELINES (BASED ON CITY OF NORTH VANCOUVER ADAPTABLE LEVEL 2) **BUILDING ACCESS** • Unobstructed internal access:

- no stairs within building circulation including corridors on residential levels
- 3' or 915mm building and suite entry doors
- Flush thresholds throughout the building (maximum ½" or 13mm height)

CIRCULATION

- Corridors minimum 4' or 1220mm wide (except for service access areas)
- Provide 5' or 1520mm turning radius inside and outside the entry corridor of each dwelling unit

SUITE CIRCULATION

- Provide wiring for an automatic door opener for the suite entry door
- Provide 2' or 610mm clear wall space adjacent to door latches where door swings toward user (pocket doors acceptable for bathrooms and bedrooms)
- Floor area for side-by-side washer-dryer accommodated in multiple suites

DOORS

• Minimum one bathroom, minimum one bedroom and storage room doors 2'-10" or 860mm clear opening

PATIOS & BALCONIES

- Minimum one door 2' 10" or 860mm clear door opening
- Minimum one patio or balcony doorsill with maximum ½" or 13mm threshold
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WINDOWS

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- Provide minimum 6-0' or 1800mm horizontal windows in living room, dining room and minimum one bedroom where sills are not more than 2'- 6" or 750mm above the floor

KITCHEN

- Continuous counter between sink and stove
- Retractable cabinet doors to be considered in unit design

MIN. ONE BATHROOM

- Toilet located adjacent to wall (min 3' or 915mm length)
- Provide turning radius within bathroom (may result from removal of vanity cabinet)
- 3' or 915mm clearance along full length of tub
- Tub control valve placed at outer edge of tub, with tub spout remaining in central position



514 3B 1624.6 ft²

513 3B



PROJECT A215294

SCALE 3/32"=1'-0" DATE NOV. 19, 2018

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03 2019.03.28 RESPONSE TO MEMORANDUM

NO. | DATE | ISSUE

01 | 2018.06.07 | ISSUED FOR ACDI

dvs architecture

UNIT LVL 2

PROJECT **EXECUTIVE PARC** MARINE+TAYLOR RESIDENTIAL

657 Marine Drive West Vancouver BC

FLOOR PLAN LEVEL 6

ADAPTABLE DESIGN GUIDELINES (BASED ON CITY OF NORTH VANCOUVER ADAPTABLE LEVEL 2) **BUILDING ACCESS**

- Unobstructed internal access:
- no stairs within building circulation including corridors on residential levels
- 3' or 915mm building and suite entry doors
- Flush thresholds throughout the building (maximum ½" or 13mm height)

CIRCULATION

- Corridors minimum 4' or 1220mm wide (except for service access areas)
- Provide 5' or 1520mm turning radius inside and outside the entry corridor of each dwelling unit

SUITE CIRCULATION

- Provide wiring for an automatic door opener for the suite entry door
- Provide 2' or 610mm clear wall space adjacent to door latches where door swings toward user (pocket doors acceptable for bathrooms and bedrooms)
- Floor area for side-by-side washer-dryer accommodated in multiple suites

DOORS

• Minimum one bathroom, minimum one bedroom and storage room doors 2'-10" or 860mm clear opening

PATIOS & BALCONIES

- Minimum one door 2' 10" or 860mm clear door opening
- Minimum one patio or balcony doorsill with maximum ½" or 13mm threshold
- Minimum 5' or 1520mm turning radius on patio /balcony
- Adaptable units to have level slabs for universal access to suite patios & balconies

WINDOWS

- Opening mechanism maximum 46" or 1168mm above floor (provide notation on window
- Provide minimum 6-0' or 1800mm horizontal windows in living room, dining room and minimum one bedroom where sills are not more than 2'- 6" or 750mm above the floor


KITCHEN

- Continuous counter between sink and stove
- Retractable cabinet doors to be considered in unit design

MIN. ONE BATHROOM

- Toilet located adjacent to wall (min 3' or 915mm length)
- Provide turning radius within bathroom (may result from removal of vanity cabinet)
- 3' or 915mm clearance along full length of tub
- Tub control valve placed at outer edge of tub, with tub spout remaining in central position

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614 3B 1624.6 ft²

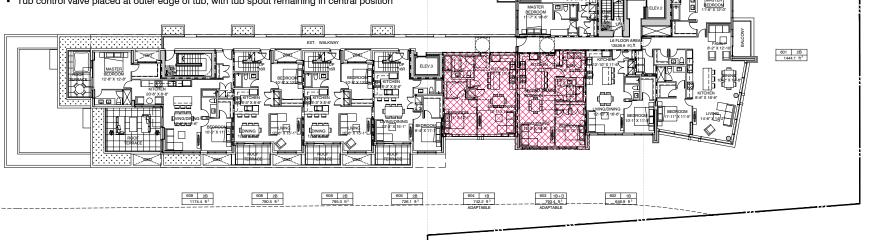613 3B 1414.2 ft²

392



PROJECT **EXECUTIVE PARC**


LEVEL 7

PROJECT A215294

SCALE 3/32"=1'-0" DATE NOV. 19. 2018



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702 3B ___1505.8 ft²

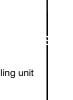












701 2B 1444.1 ft²

MARINE+TAYLOR RESIDENTIAL

657 Marine Drive West Vancouver BC

FLOOR PLAN

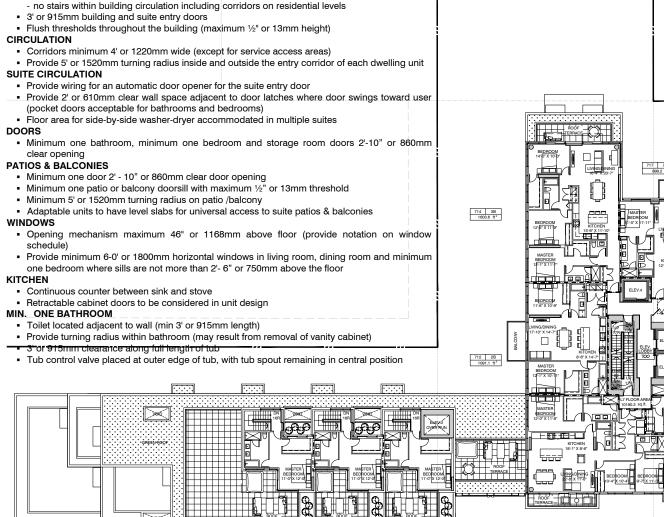

606 UPPER

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ADAPTABLE DESIGN GUIDELINES

• Unobstructed internal access:

BUILDING ACCESS

(BASED ON CITY OF NORTH VANCOUVER ADAPTABLE LEVEL 2)

BUILDING ACCESS

- 3' or 915mm suite entry doors
- Flush thresholds throughout the building (maximum 1/2" or 13mm height)

CIRCULATION

■ Provide 5' or 1520mm turning radius inside and outside the entry corridor of each dwelling unit

SUITE CIRCULATION

- Provide wiring for an automatic door opener for the suite entry door
- Provide 2' or 610mm clear wall space adjacent to door latches where door swings toward user (pocket doors acceptable for bathrooms and bedrooms)
- area for side-by-side washer-drver accommodated in multiple suites

DOORS

· Minimum one bathroom, minimum one bedroom and storage room doors 2'-10" or 860mm clear opening

PATIOS & BALCONIES

- Minimum one door 2' 10" or 860mm clear door opening
- Minimum one patio or balcony doorsill with maximum 1/2" or 13mm threshold
- Minimum 5' or 1520mm turning radius on patio
- Adaptable units to have level slabs for universal access to suite patios & balconies

WINDOWS

- Opening mechanism maximum 46" or 1168mm above floor (provide notation on window schedule)
- Provide minimum 6-0' or 1800mm horizontal windows in living room, dining room and minimum one bedroom where sills are not more than 2'- 6" or 750mm above the floor

KITCHEN

- Continuous counter between sink and stove
- Retractable cabinet doors to be considered in unit


MIN. ONE BATHROOM

- Toilet located adjacent to wall (min 3' or 915mm length)
- Provide turning radius within bathroom (may result from removal of vanity cabinet)
- 3' or 915mm clearance along full length of tub
- Tub control valve placed at outer edge of tub, with tub spout remaining in central position
- · Solid blocking provided in walls of tub / shower and toilet areas, and behind towel bars
- Adjustable height shower head or hand-held shower head on adjustable bracket

The proposed project will provide 18 residential units (20% of total) that will meet Level 2 of the City of North Vancouver's Adaptable Design Guidelines. In addition, the remaining residential units in the project will feature basic adaptable design elements to allow for future needs:

- In one bathroom, solid blocking provided in walls of tub / shower and toilet areas and behind towel bars:
- Pressure balanced tub / shower valves;
- One bedroom is have a clear opening door width of not less than 800 mm (31.5");
- · Bedrooms to have a telephone jack;
- Windows to have easily grasped and operated mechanism for opening and locking;
- Kitchens to have lever handle faucets and cabinet handles which can be easily used with an open hand (for example "D" or "J" cabinet handles;
- Kitchens designed so that the range and sink are adjacent or with a continuous counter in between;
- Adjustable shelves in cabinets;
- Outlets, switches and controls to be located between 455 mm (18") and 1,200 mm (48") above the floor;
- Non-slip flooring in the kitchen and one bathroom;

• Unit entries to have door handles at 1,000 mm (40") above the floor with deadbolts placed immediately above or below.

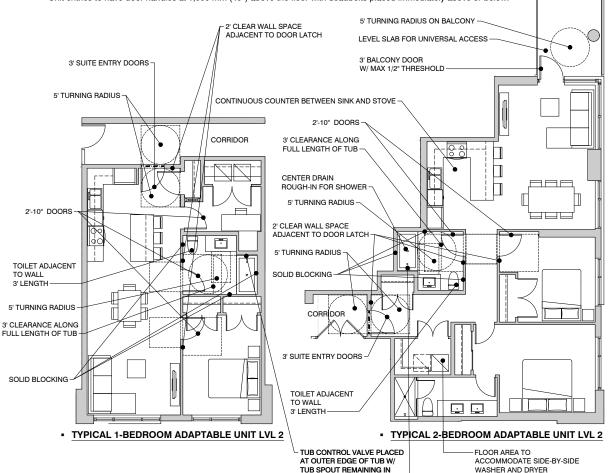

CENTRAL POSITION

dvs architecture 260 - 1770 Burrard Street Vancouver BC V6J 3G7



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03 2019 03 28 RESPONSE TO MEMORANDUM

NO. | DATE | REVISION

PROJECT

EXECUTIVE PARC MARINE+TAYLOR RESIDENTIAL

657 Marine Drive West Vancouver BC

TYPICAL UNIT PLANS ADAPTABLE LEVEL 2

PROJECT A215294

DRAWN .II

SCALE 1/4"=1'-0" DATE NOV. 19. 2018



March 19, 2019

Lisa Berg
Senior Community Planner
District of West Vancouver
750 17th Street, West Vancouver
V7V 3T3

Re: 2019 Locals First Program – 657 & 675 Marine Drive and 660 Clyde Avenue

Executive Parc

Dear Lisa,

Executive Park Limited Partnership will be developing 89 Market and Rental Homes known as the "Executive Parc", conveniently located near the corner of Marine Drive and Taylor Way – the gateway to West Vancouver.

In recognition of the District of West Vancouver's preference for local residents and employees to have first priority on new multi-family housing being developed in the District, Executive is introducing a Locals First Program that will give Locals a first priority to purchase or rent homes at Executive Parc.

Under the Locals First Program, Executive defines a "Local" as a resident, an employee or a business operator who lives and/or works on the North Shore, specifically within the District of West Vancouver, the District of North Vancouver and the City of North Vancouver. Accordingly, Executive offers the following Locals First Program for Market Homes and Rental Homes:

Locals First - Market Homes

With several home options to choose from, sales of all homes at Executive Parc will be offered exclusively to Locals for the first 30 days of marketing.

The 30 day opportunity commences on the day following the filing of Executive Parc's Disclosure Statement. In order to qualify under the Locals First Program, the Purchaser will need to provide a current proof of residence or workplace, or sufficient proof that he or she will be moving to or working in a North Shore Municipality.

The Purchaser will be required to declare, in writing, that he or she qualifies as a Local under this Program.

Such Purchaser will be limited to one home only during this period of exclusivity.

Locals First - Rental Homes

Executive will dedicate 21 homes for the life of the building as rental suites, and these rental homes at Executive Parc will be offered exclusively to Locals during the first 30 days that Executive begins accepting lease applications.

Renters need not be a North Shore resident prior to applying, but will need to substantiate that they will be employed or operating a business on the North Shore by the commencement of their lease period in order to qualify as a Local.

The tenant residing in the rental suite must be the named Local on the tenancy agreement.

We appreciate the opportunity to put forward this Locals First Program, and look forward to its successful implantation.

Regards,

Greg Santa

Development Manager

C St

8TH FLOOR, 1080 HOWE STREET, VANCOUVER, BC CANADA V6Z 2T1 TEL: 604 642 5252 FAX: 604 642 5255 WWW.EXECUTIVEGROUPDEVELOPMENT.COM

BC BUILDING SCIENCE

611 BENT COURT, NEW WESTMINSTER, B.C., V3M 1V3, TEL: 604-520-6456, FAX: 604-520-6496
BUILDING ENVELOPE & STRUCTURAL CONSULTANTS - WWW.BCBUILDINGSCIENCE.COM

March 22, 2019

District of West Vancouver Planning & Development Attn: Lisa Berg

SUBJECT: BC ENERGY STEP CODE COMPLIANCE

ADDRESS: 677 MARINE DRIVE, WEST VANCOUVER

We have been retained as the Building Envelope and Energy Consultant for the development at the above noted address. The energy targets are aligned with requirements of the BC Building Code 2018 - BC Energy Step Code (BS-ESC). The energy performance metrics are: TEDI (Thermal Energy Demand Intensity) and TEUI (Total Energy Use Intensity).

We have developed an energy model and executed a variety of design scenarios and energy conservation measures to comply with the BC-ESC. As the project is at preliminary design stage and detailed designs of building envelope, mechanical, and electrical systems are not available yet, we established the basis of design for such systems to comply with the TEDI and TEUI targets (Step 2 and Step 3 were studied preliminarily).

Based on the preliminary energy modelling results, the following represents our strategy to comply with BC-ESC. The details related to each strategy are functions of the required Step metrics (Step 1-4) and will be obtained and provided at Building Permit that envelope/mechanical/electrical designs are available for detailed modelling.

- High Thermal Performance Envelope: A combination of high efficiency window wall and curtain wall, appropriate exterior insulation on concrete and steel framing walls, and high thermal performance roofs and exposed floors will be considered in the detailed design of building envelope. Improved detailing at interfaces will be used to enhance the overall thermal performance of the building.
- Air Tight Building: Depending upon the Step requirement, an enhanced air barrier commissioning may be
 taken to achieve air tight building design beyond the minimum BC Building Code 2018. This will contribute to
 further reduction of TEDI and TEUI of the building.
- Window to Wall Ratio (WWR): An appropriate WWR will be obtained to create a balance between liveability, daylight usage, solar heat gain, and thermal losses through windows and framings.
- High Efficiency Heat Recovery Ventilators (HRVs): High efficiency HRVs will be considered for all suites
 and amenity spaces to provide high quality ventilation and reduce heating demand. This will significantly
 reduce the TEDI and TEUI measures related to ventilation requirements in the building.
- High Efficiency HVAC system: High efficiency boilers (condensing) or heat pumps will be considered for space heating to reduce TEUI in the building. High efficiency boilers will be considered for service water heating in the building that significantly reduces TEUI in the building.

Should you require any additional information, please contact our office.

Regards.

BC BUILDING SCIENCE LTD.

Prepared by: Farshid Bagheri, Ph.D., P.Eng.

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