



Project Inf	formation			GENERAL NOTES
Property Owner	Alex and Daniel Cleland			These drawings have been prepared by D3 Dimension Drafting and Design Inc. to c
Site Address	99 Deep Dene Place West Van V7S 1A3			the current residential standards of the BCBC (2018).
Project Type	Renovation			The Builder is responsible for ensuring that all construction conforms to provincial a
Jurisdiction Authority	District of West Vancouver			codes and bylaws.
Legal Description PID	LOT 109 BLOCKS 6 AND 7 CA 009-302-930	PILANO ESTATI	ES PLAN 10794	Dimensions take precedence to scale drawings.
Zone	RS3			Dimensions to be taken from outside face of sheathing for exterior walls and face of interior walls as shown.
Consultan				Place footings to undisturbed, sound bearing soil below frostline (2' below grade).
				Structural lumber to be No.2 SPF or better
Surveyor			604-603-6747	Between all exterior top plates and double plates, require 6 MIL poly.
Designer Engineer	D3 Dimension Drafting and Desi	ign Inc.	004-003-0747	6 MIL poly is required at all connection points between interior and exterior walls.
Builder				
Energy Consultant				Floor assembly to be constructed with manufacture I-Joist
Arborist				Lumber in contact with concrete to be damproofed (sill gasket) , and anchored with anchor bolts at 16" O.C. max
Proiect Da	ata and Devel	opmer	t Staticics	Lintels to be #2-2x10 U.N.O TYP.
Site				Double joists at parallel partitions (opt. 2x10 blocking at 24" O.C.)
Lot Line North	45.778 m /150.19 ft			Dwelling must meet current B.C. ventilation code
Lot Line East	24.497 m / 80.37 ft			All operable windows to be standard sliding glazing, U.N.O.
Lot Line North West	15.051 m / 49.37ft			Waterproof wallboard required on bathroom walls
Lot Line South West	32.233 m / 105.75 ft			Provide a bond-breaking material between foundation or rock and slabs.
Lot Line South	65.791 m / 215.84 ft			
Site Width	27.01 m / 88.61 ft			Exterior dimensions to be measured from outside of sheathing.
Site Area	1537.6248 sqm / 16529.06 sf			All new interior walls to be dimensioned to outside of stud.
Single family dwelling				All existing interior walls to be dimensioned to outside of drywall.
Coverage	Required/Allowed	Proposed	Notes	All Construction and installation of materials and equipment shall be done in accordance good building practices, following manufacturers instructions and conforming to the
Principle Site Coverage	30% (4958.718 sf)	Unchanged		
Permeable Area (Front) Set Backs	50% (2998 sf)	873 sf Proposed	Unchanged Notes	All Structural specifications to be designed and certified by a structural engineer. And discrepancies must be brought to D3 Dimension Drafting and Design Inc. attention.
Front yard:	9.1m/ 29.86 ft	9.11 m/29.89 f		It is the responsibility of the contractor or builder to check and verify all dimensions a
Rear yard:	9.1m/ 29.86 ft	16.27 m/53.37		ensure all work conforms to all local bylaws ad regulation, and to the current edition BCBC
Side yard (Left):	10% Site Width (2.7m/8.86 ft)	3.05 m/10.0 ft	Unchanged	D3 Dimension Drafting and Design Inc. accepts no liability for error or omissions.
Side yard (Right):	10% Site Width (2.7m/8.86 ft)	2.41 m/7.92 ft	Variance	
Combined Side	25% Site Width (6.75m/22.2ft)	5.46 m/17.92 f	t Variance	These plans conform to the B.C. Building Code, 2018 ED.
Floor Area	Required/Allowed	Proposed	Notes	C1 C2 (C1+C2) (C1+C2/2) Length ((C1+C2/2)*Length)
Cellar	-	782 sf	Unchanged	A-B 603.6 603.7 1207.3 603.65 22.6 13642.49 B-C 603.7 604.2 1207.9 603.95 18.3 11052.285
Basement	-	-	-	C-D 604.2 604.0 1208.2 604.1 2.3 1389.43 D-E 604.0 603.9 1207.9 603.95 27.8 16789.81
First Floor	-	1942 sf	Unchanged	E-F 603.9 603.9 1207.8 603.9 20.0 12078 F-G 603.9 603.9 1207.8 603.9 2.0 1207.8
Second Floor	-	1979 sf	Existing 1183 sf.	G-H 603.9 603.1 1207.0 603.5 49.0 29571.5 H-I 603.1 603.1 1206.2 603.1 2.2 1326.82
Floor Area Ratio Total	30% 4958.718 sf	29%		I-J 603.1 600.3 1203.4 601.7 2.5 1504.25 J-K 600.3 600.3 1200.6 600.3 7.8 4682.34
Garage	4950.7 10 SI	4717 sf 439 sf	Evaluation as par $120.09(5)(a)(b)$	K-L 600.3 603.3 1203.6 601.8 2.5 1504.5 i) L-M 603.3 603.3 1206.6 603.3 5.4 3257.82
Building Height	7.62m / 25 ft	23.23 ft	Exclusion as per 130.08(5)(a)(Existing: 22.83 ft	I/ M-N 603.3 600.3 1203.6 601.8 2.5 1504.5 N-O 600.3 600.3 1200.6 600.3 7.8 4682.34
Number of Storeys	2 + Basement	2 + Basement	Unchanged	O-P 600.3 603.4 1203.7 601.85 2.5 1504.625 P-Q 603.4 603.4 1206.8 603.4 1.4 844.76
Building Face Envelope	6.7 m / 21.98 ft	< 6.70m		Q-R 603.4 600.2 1203.6 601.8 15.2 9147.36
Secondary Suite	Required/Allowed	Proposed	Notes	S-T 600.2 603.7 1203.9 601.95 9.4 5658.33
First Floor		437 sf		T-U 603.7 603.7 1207.4 603.7 4.1 2475.17 U-V 603.7 604.2 1207.9 603.95 21.2 12803.74
Second Floor		527 sf		V-W 604.2 604.1 1208.3 604.15 3.9 2356.185 W-X 604.1 604.2 1208.3 604.15 10.8 6524.82
Total	968 sf	964 sf		X-A 604.2 603.6 1207.8 603.9 14.0 8454.6 259.3 156424.30
PLAN # 1	583			Average Grade: 603.26
-May only be issued for the -Are issued with the unders their work only to the exten same.	sued by D3 Dimension Drafting Desi e designated purpose indicated standing that D3 Dimension Drafting nt of issuing corrected copies in the ension Drafting Design Ltd., is and w undable.	g Design Ltd., will event of an error	or omission of the	
 Interior/Exterior renovati Addition 	ion			


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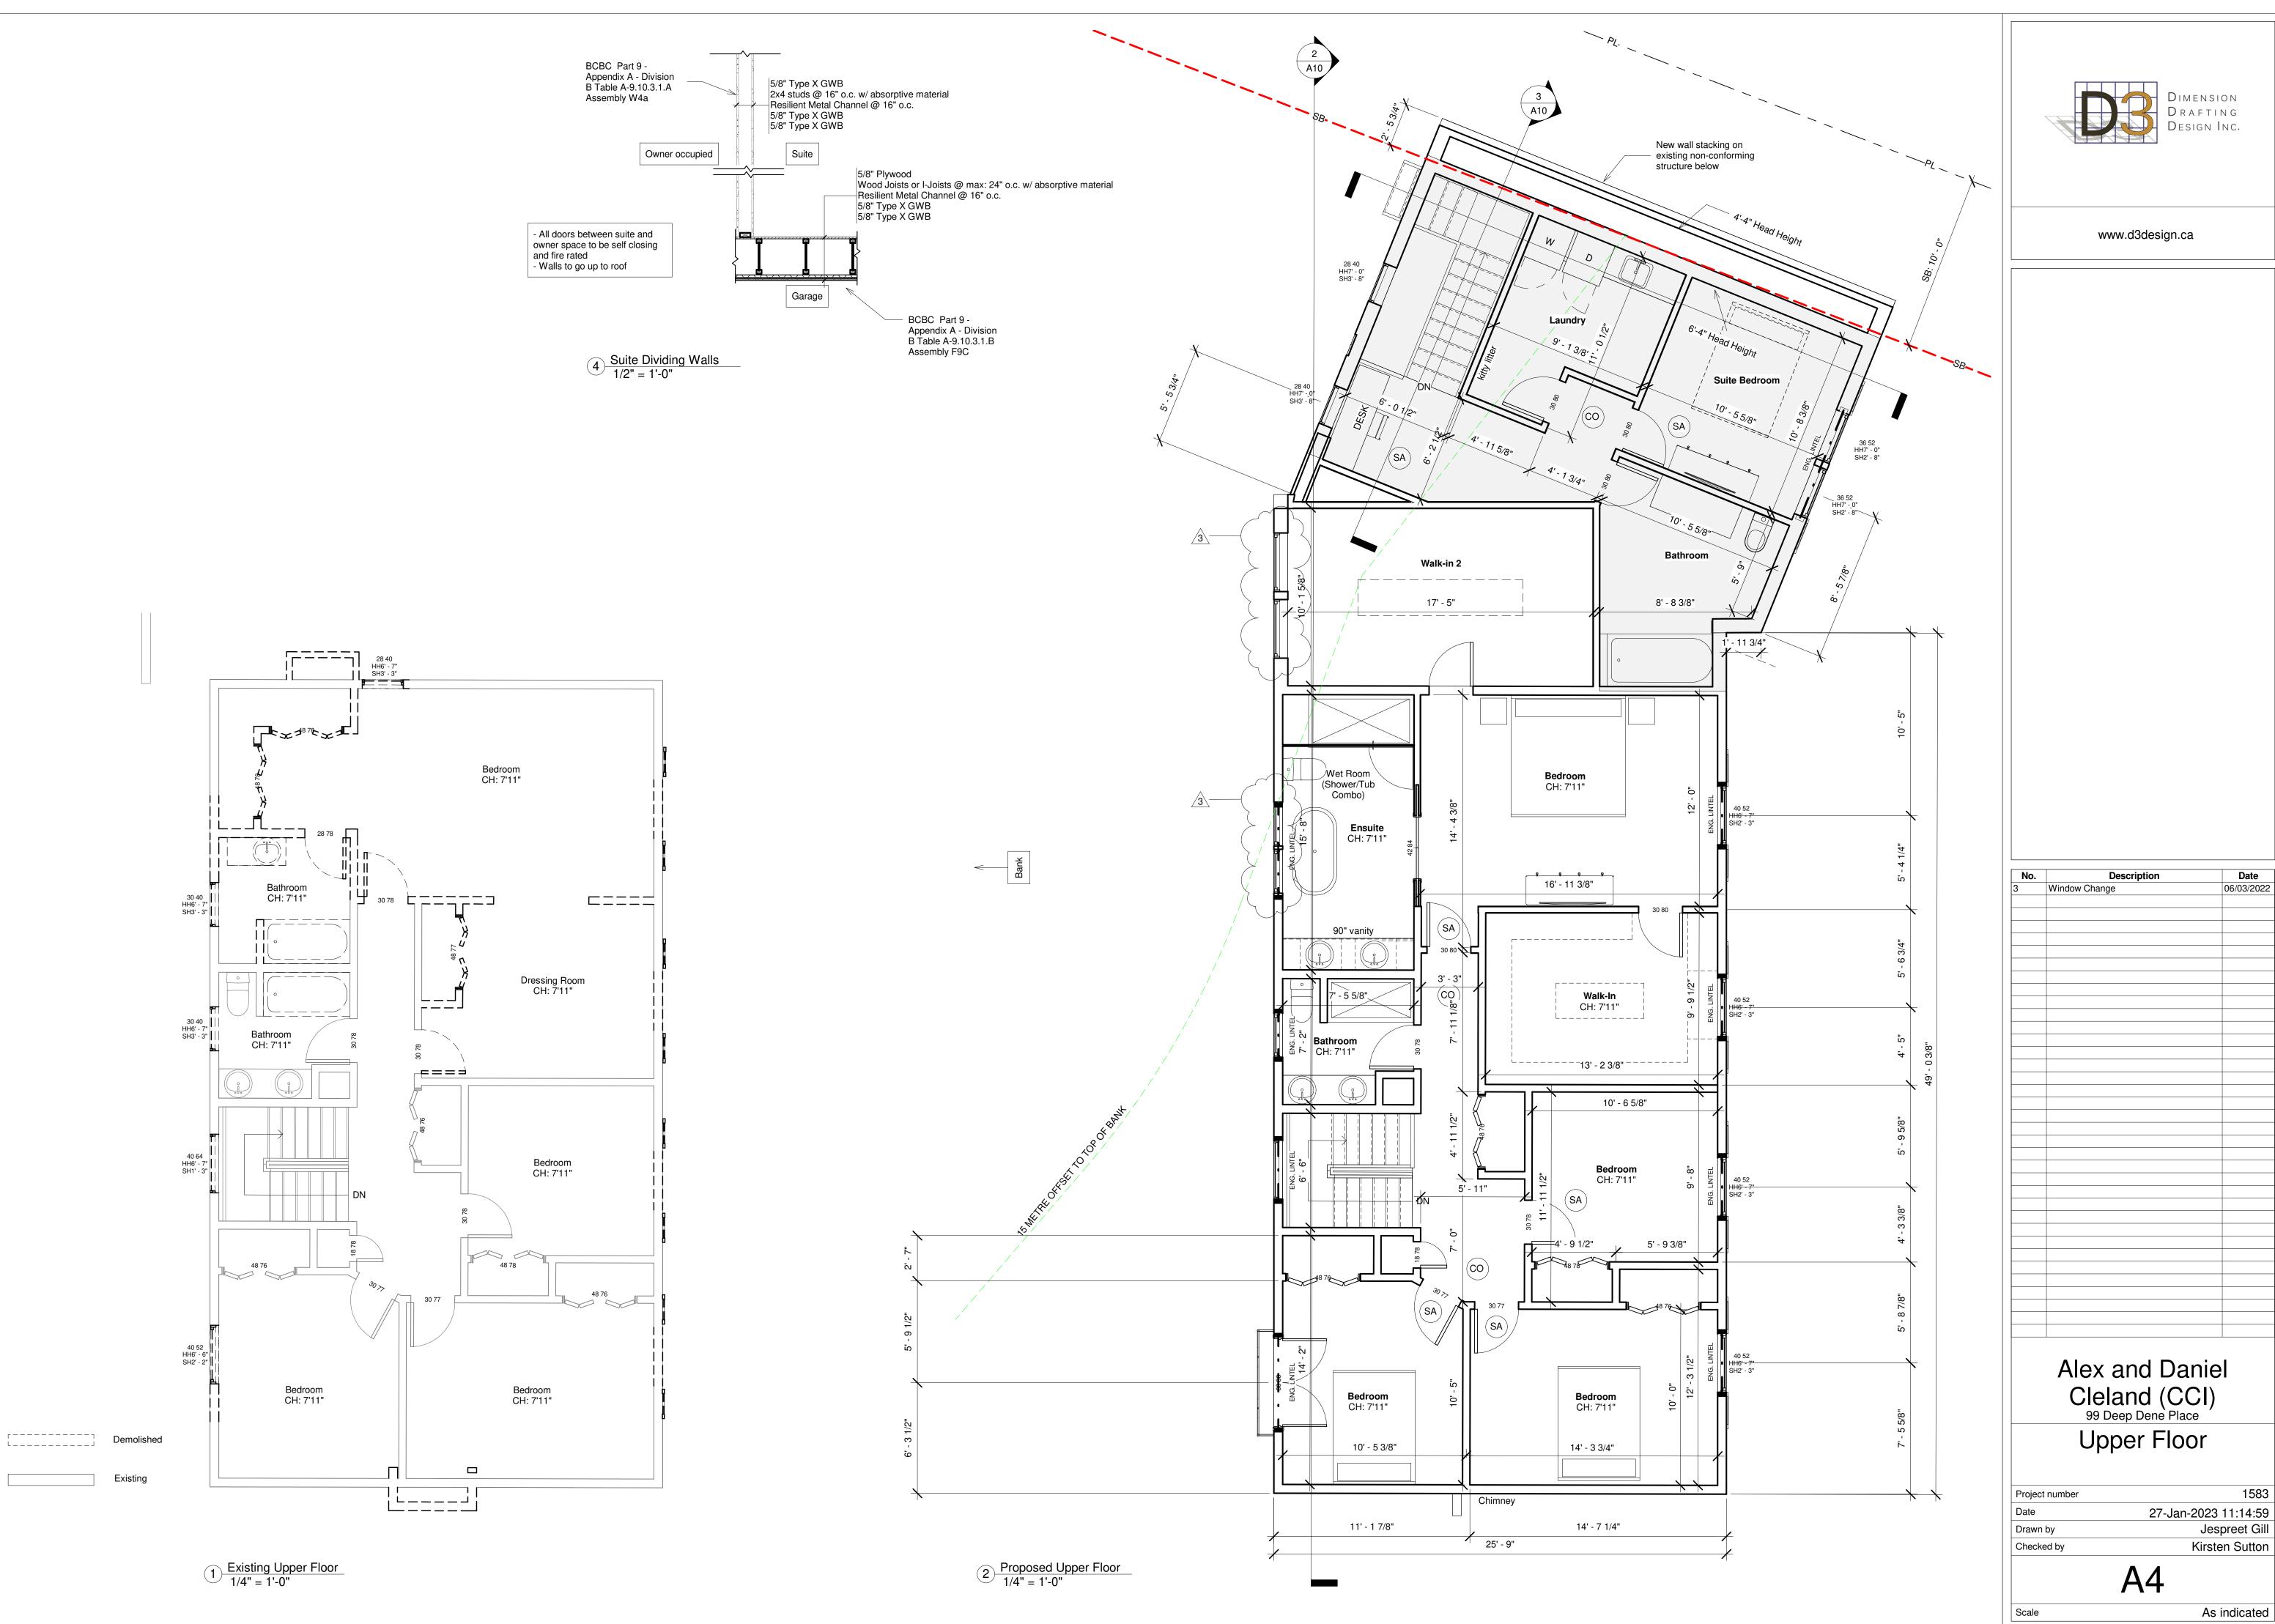


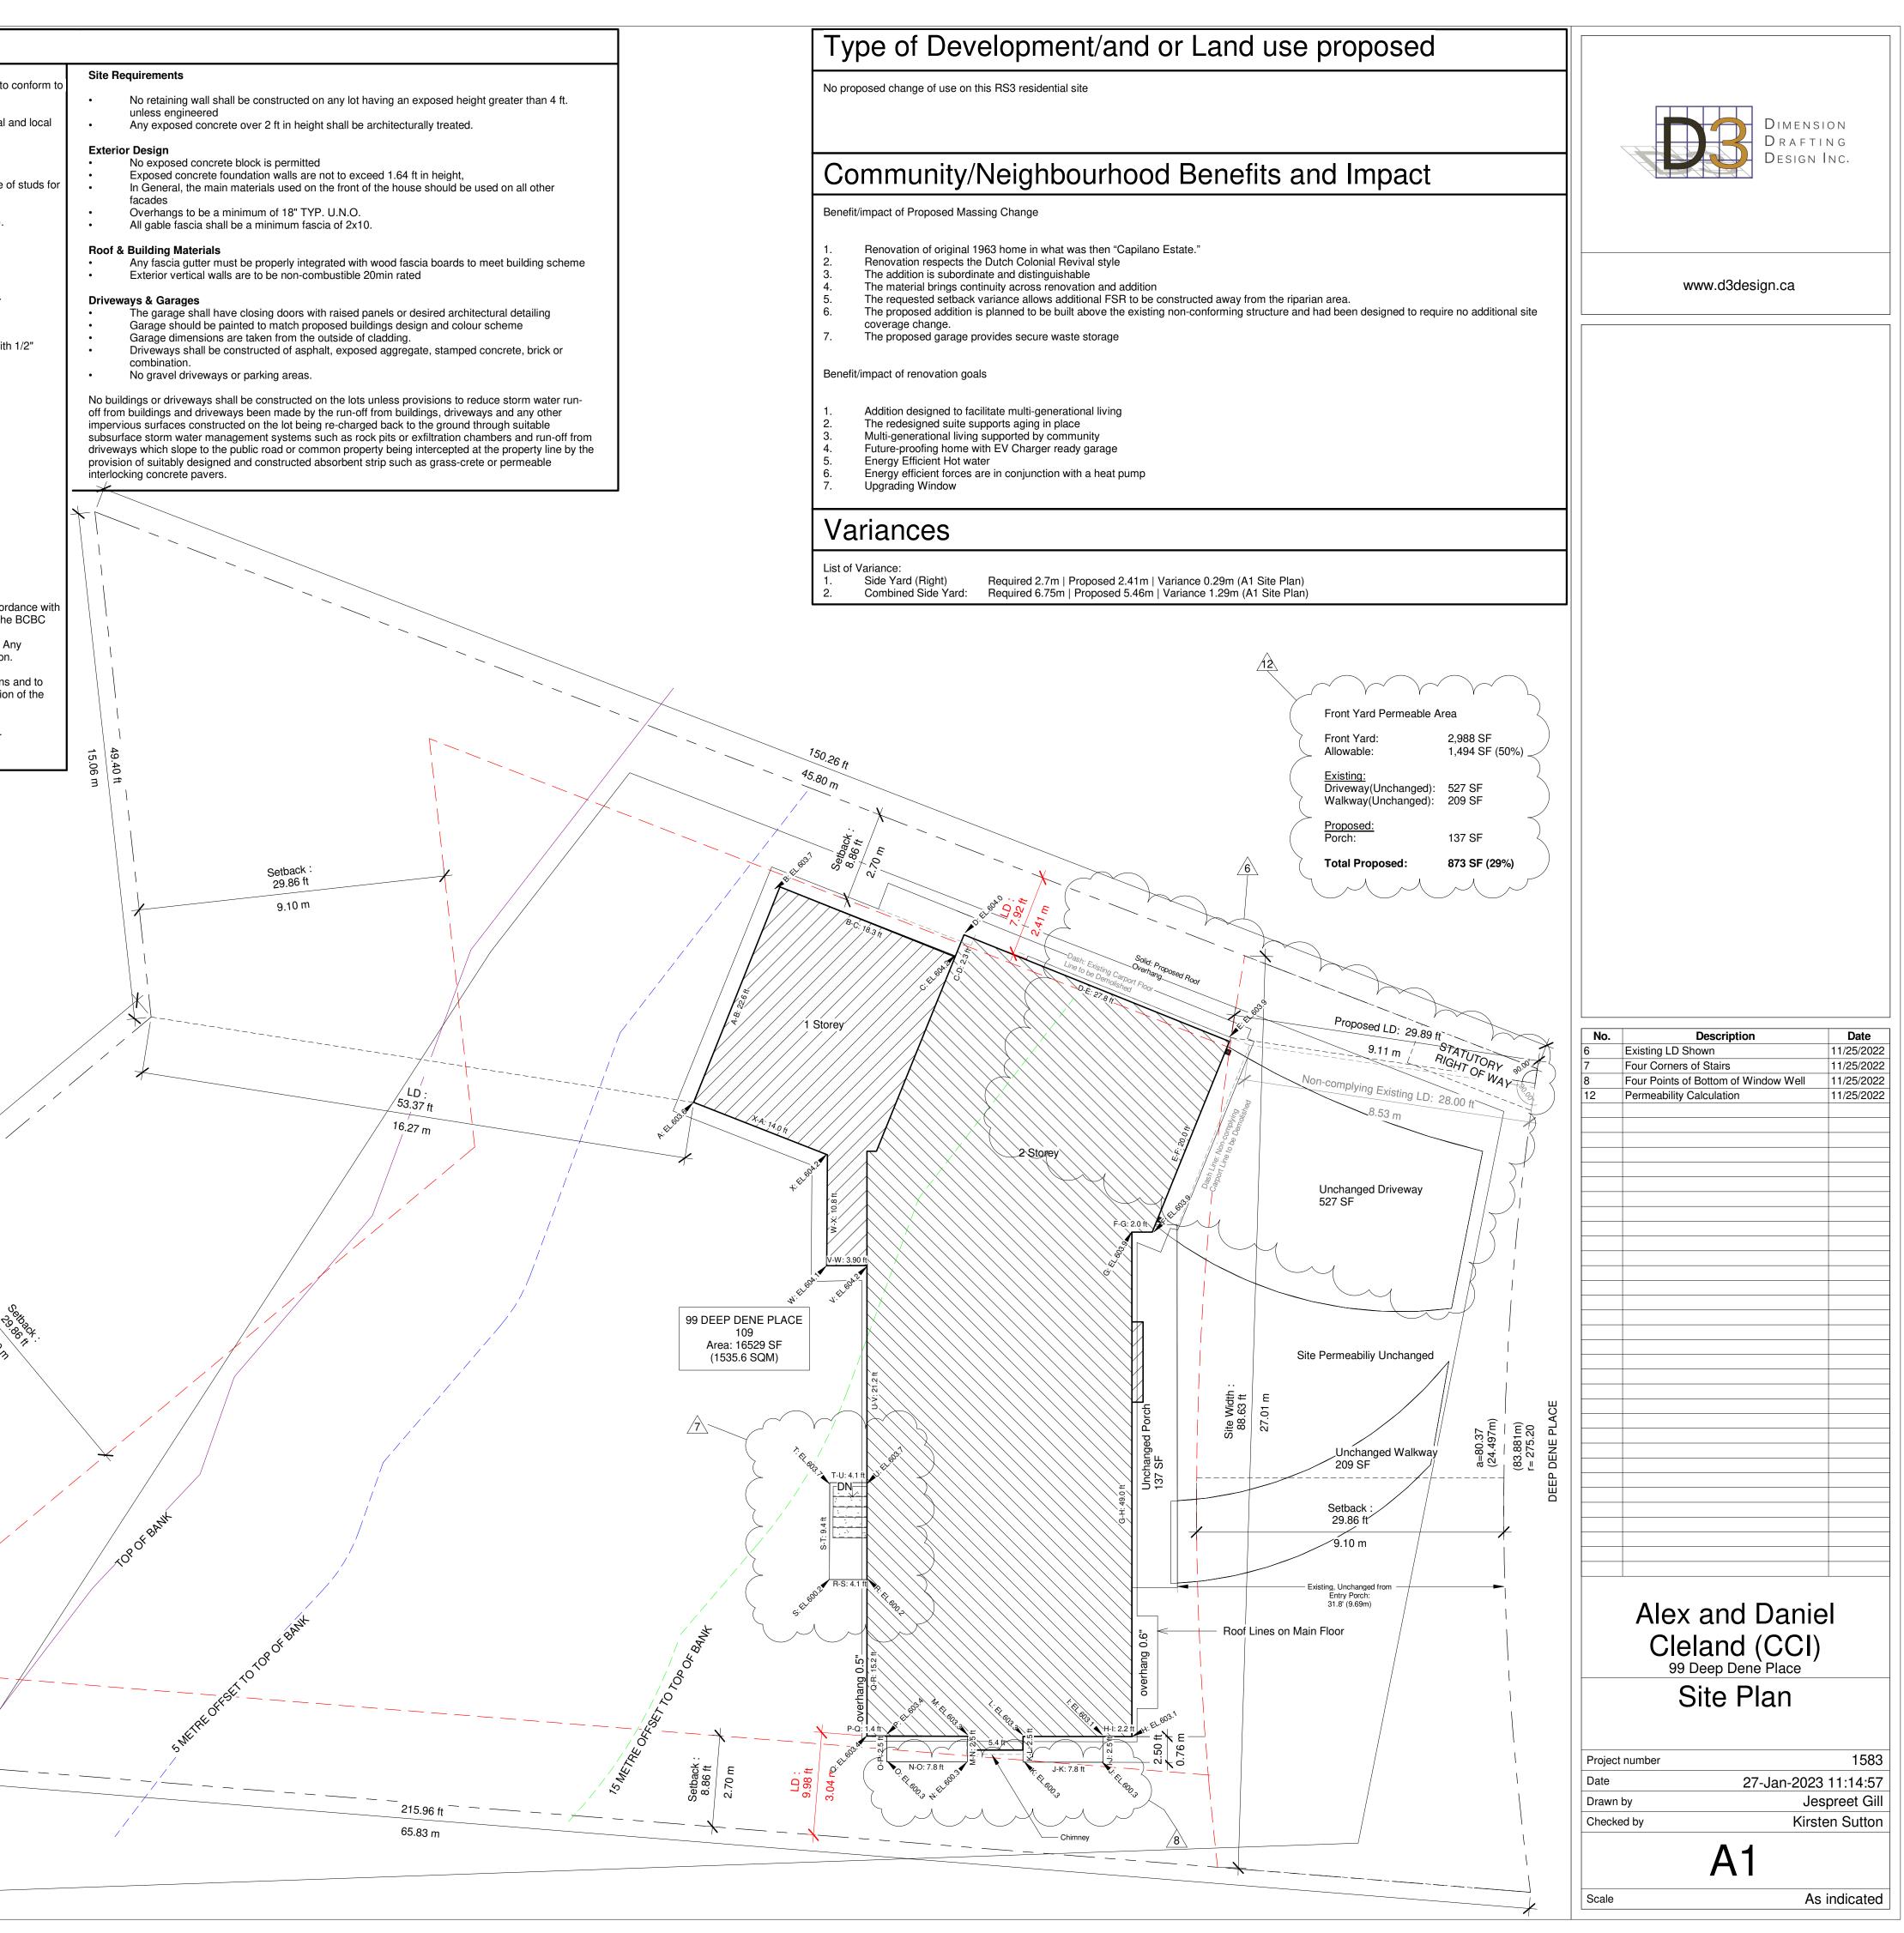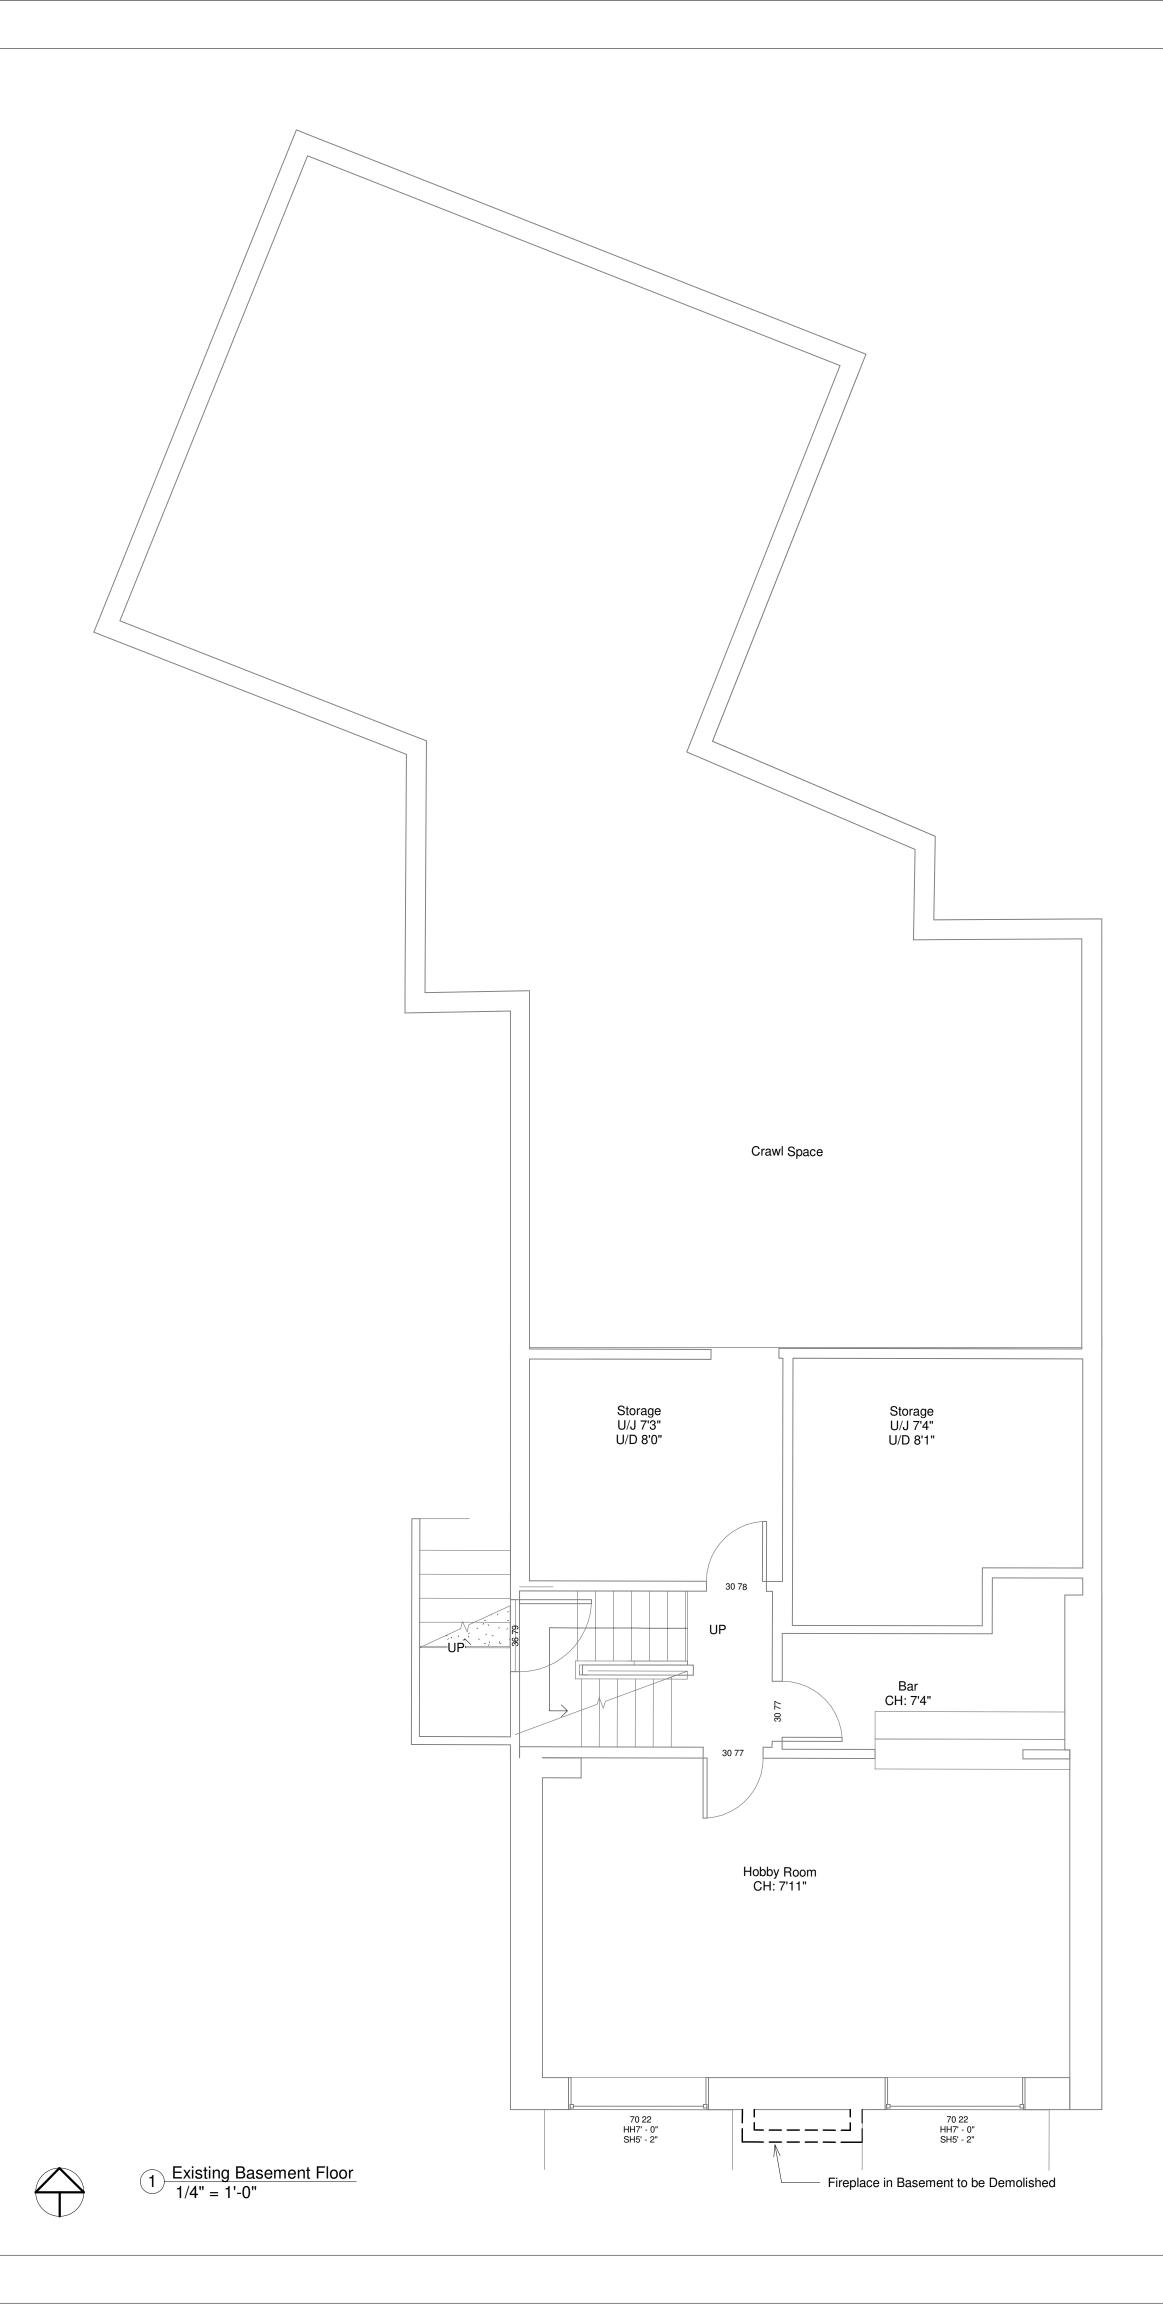

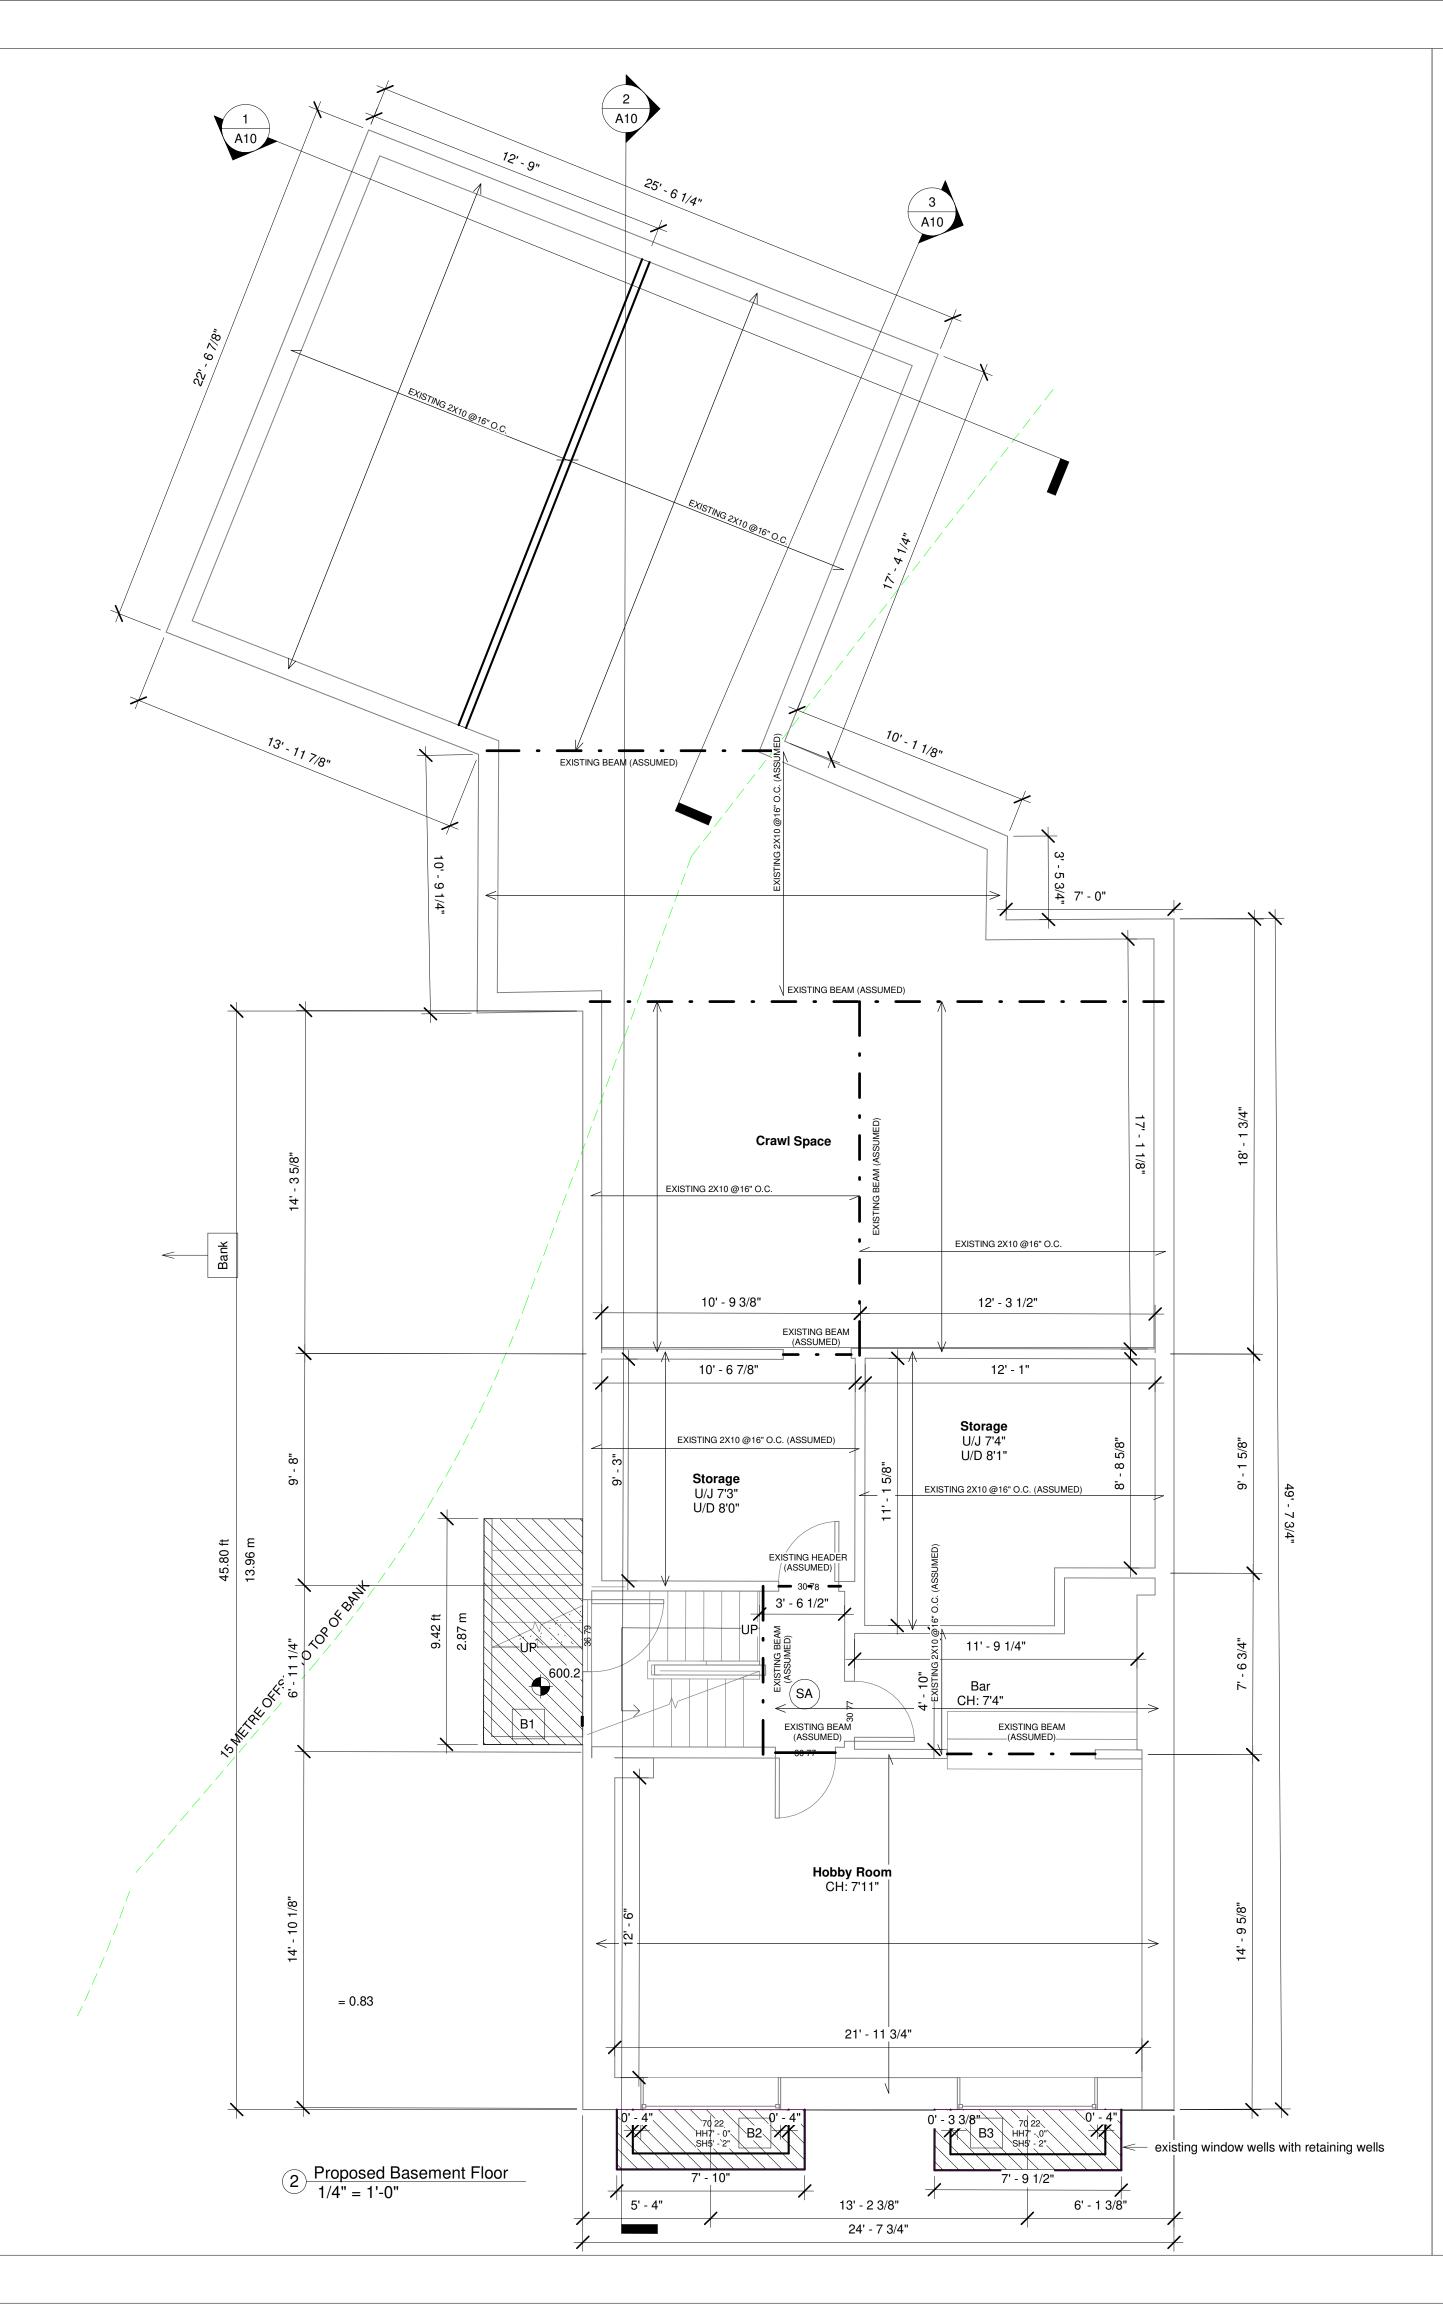

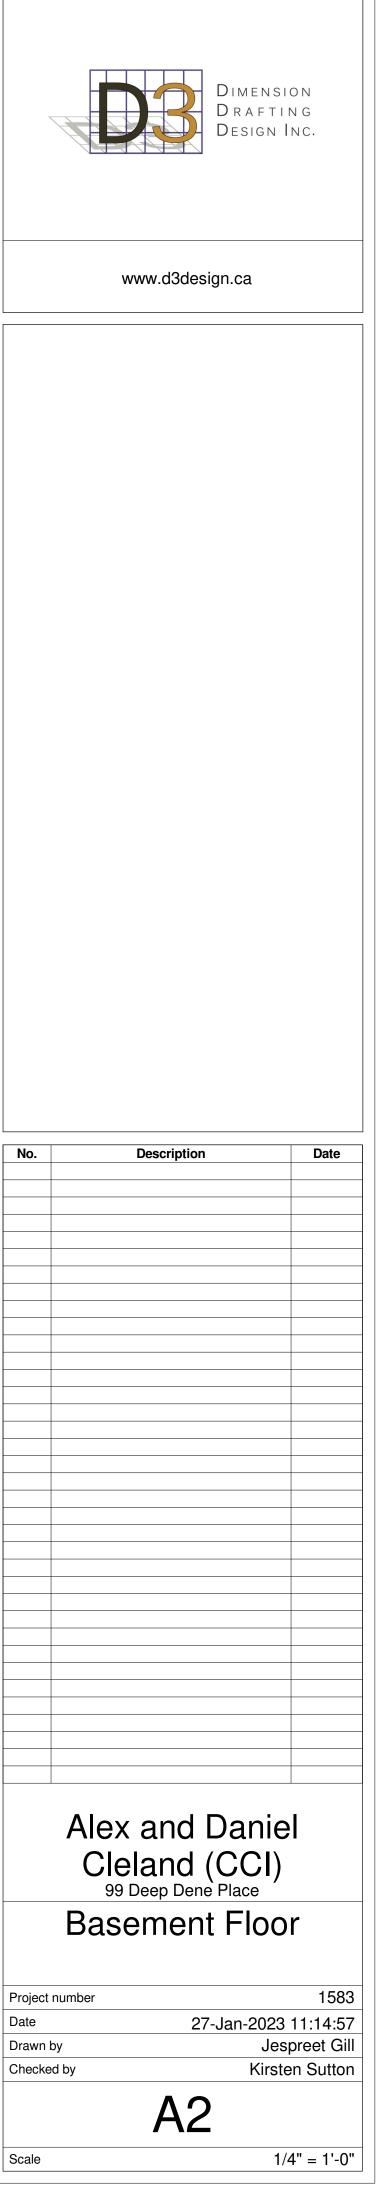



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Date 06/03/2022

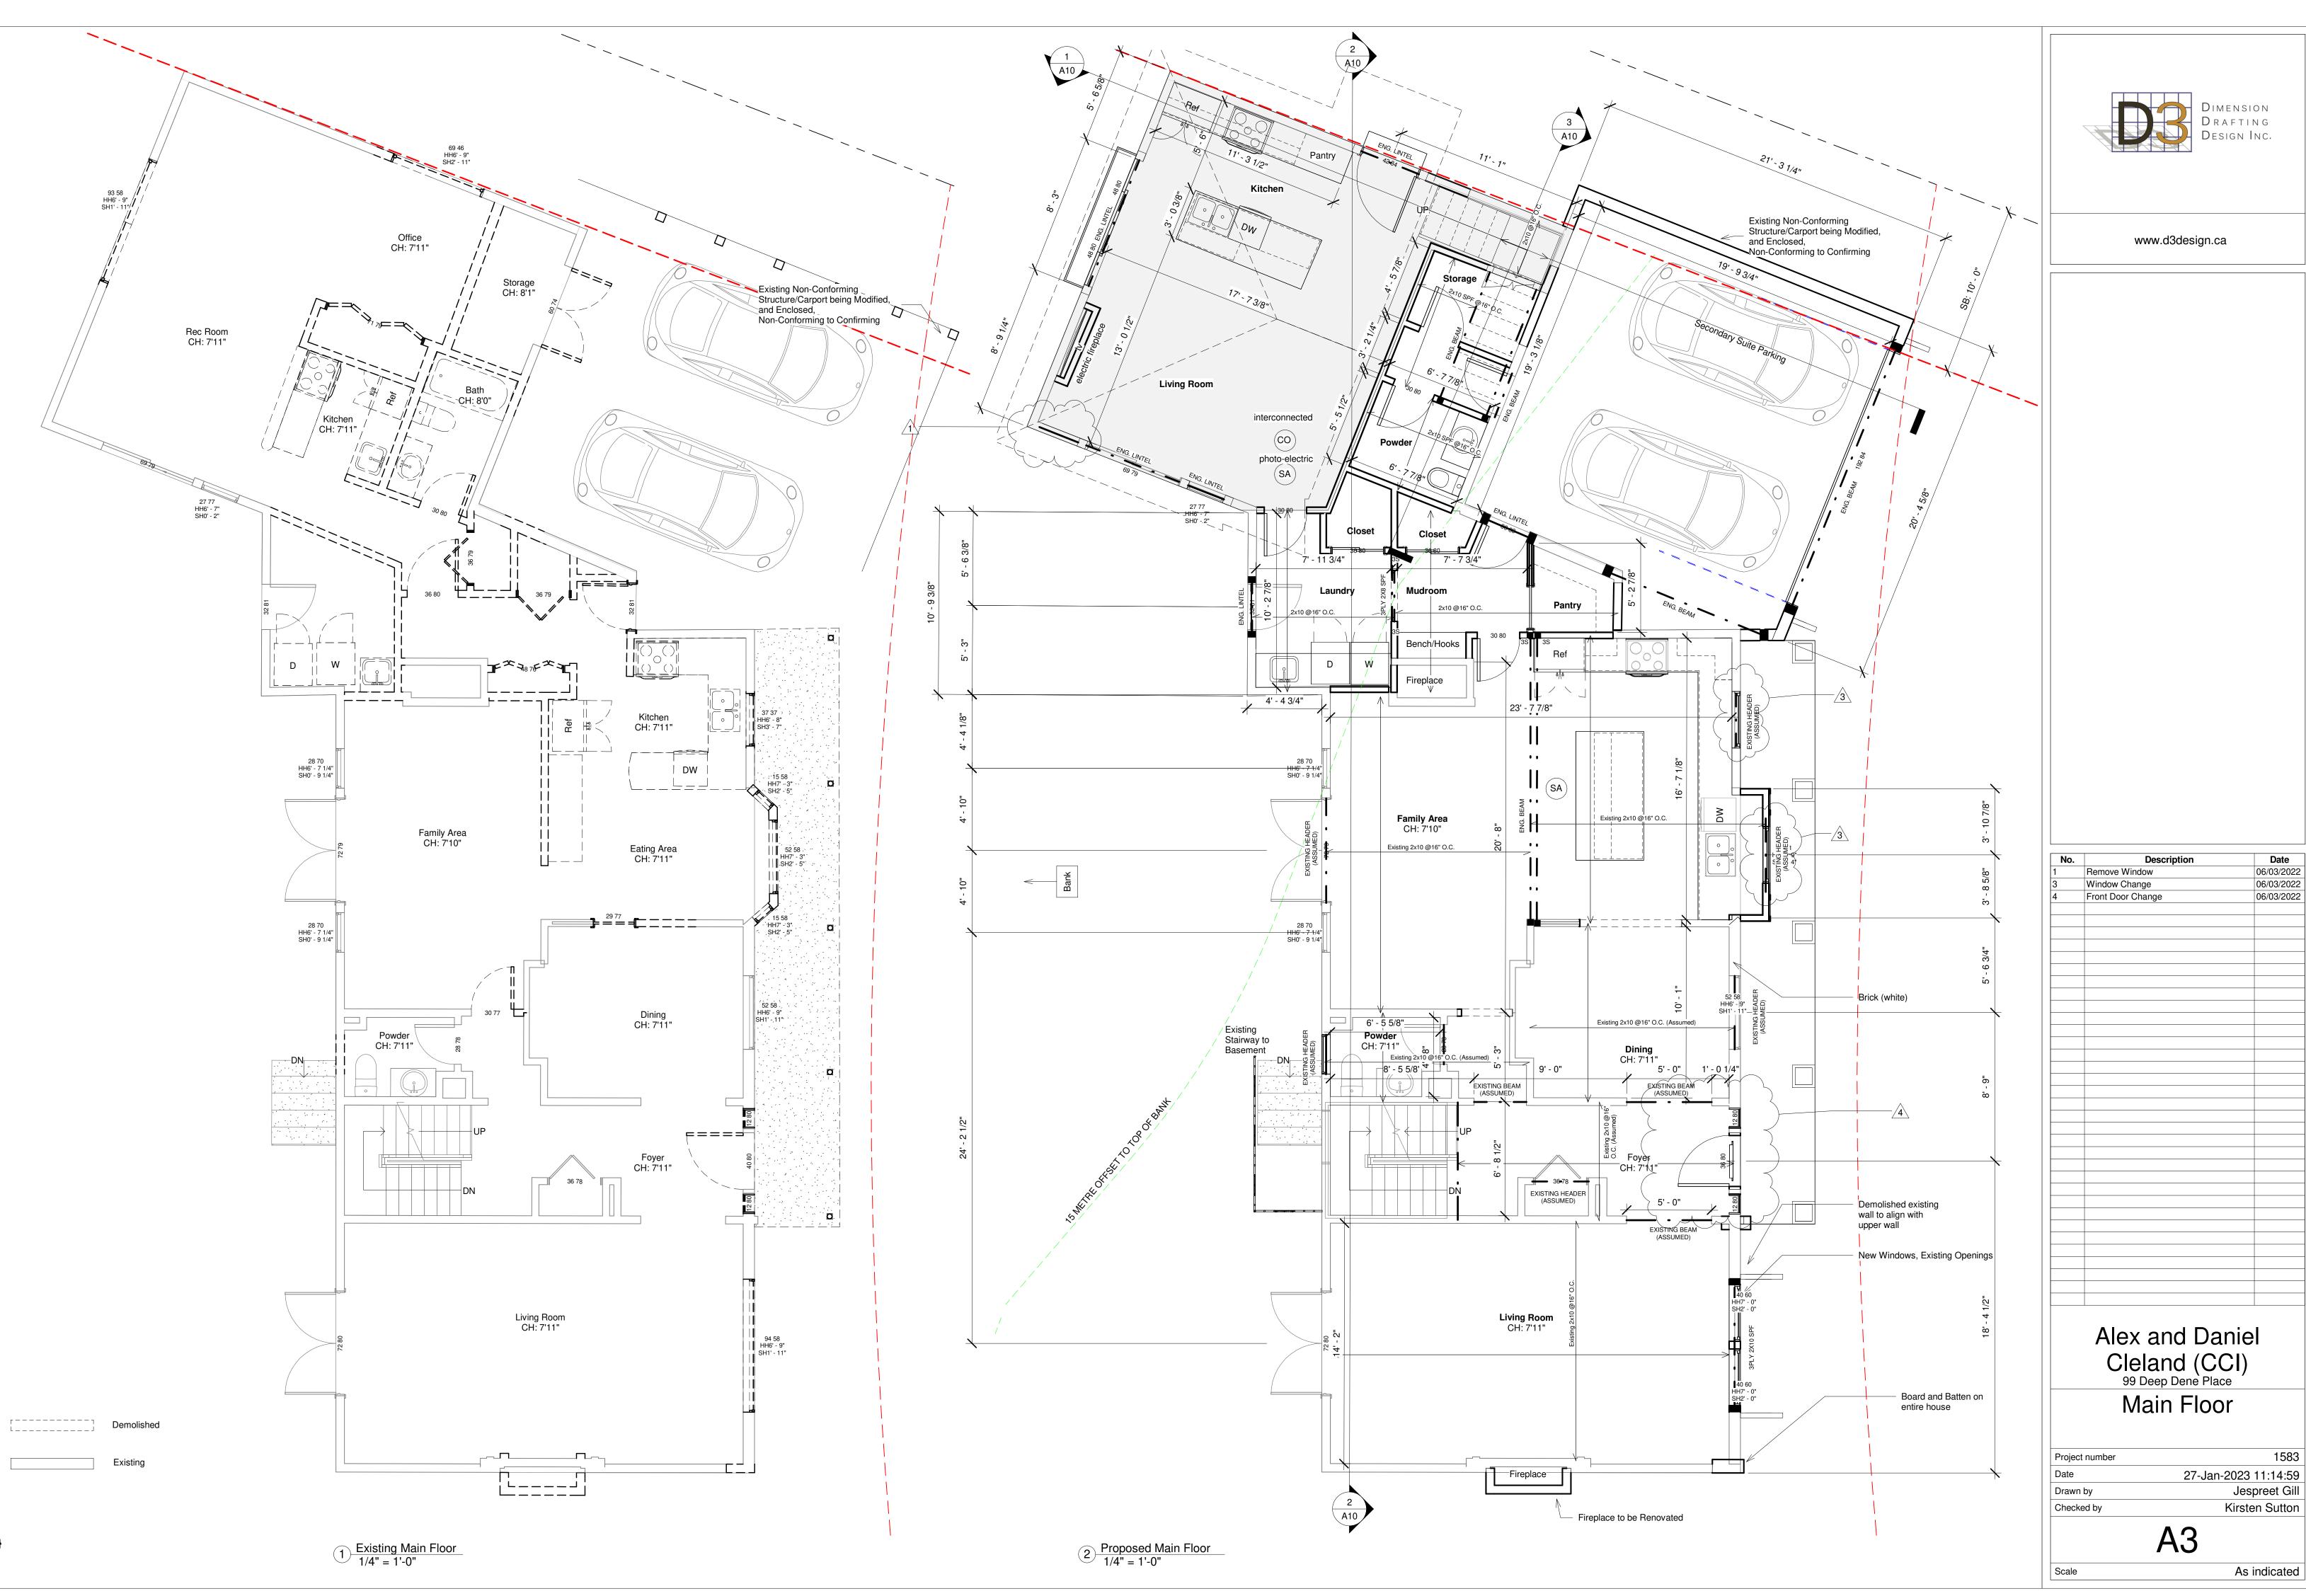1583



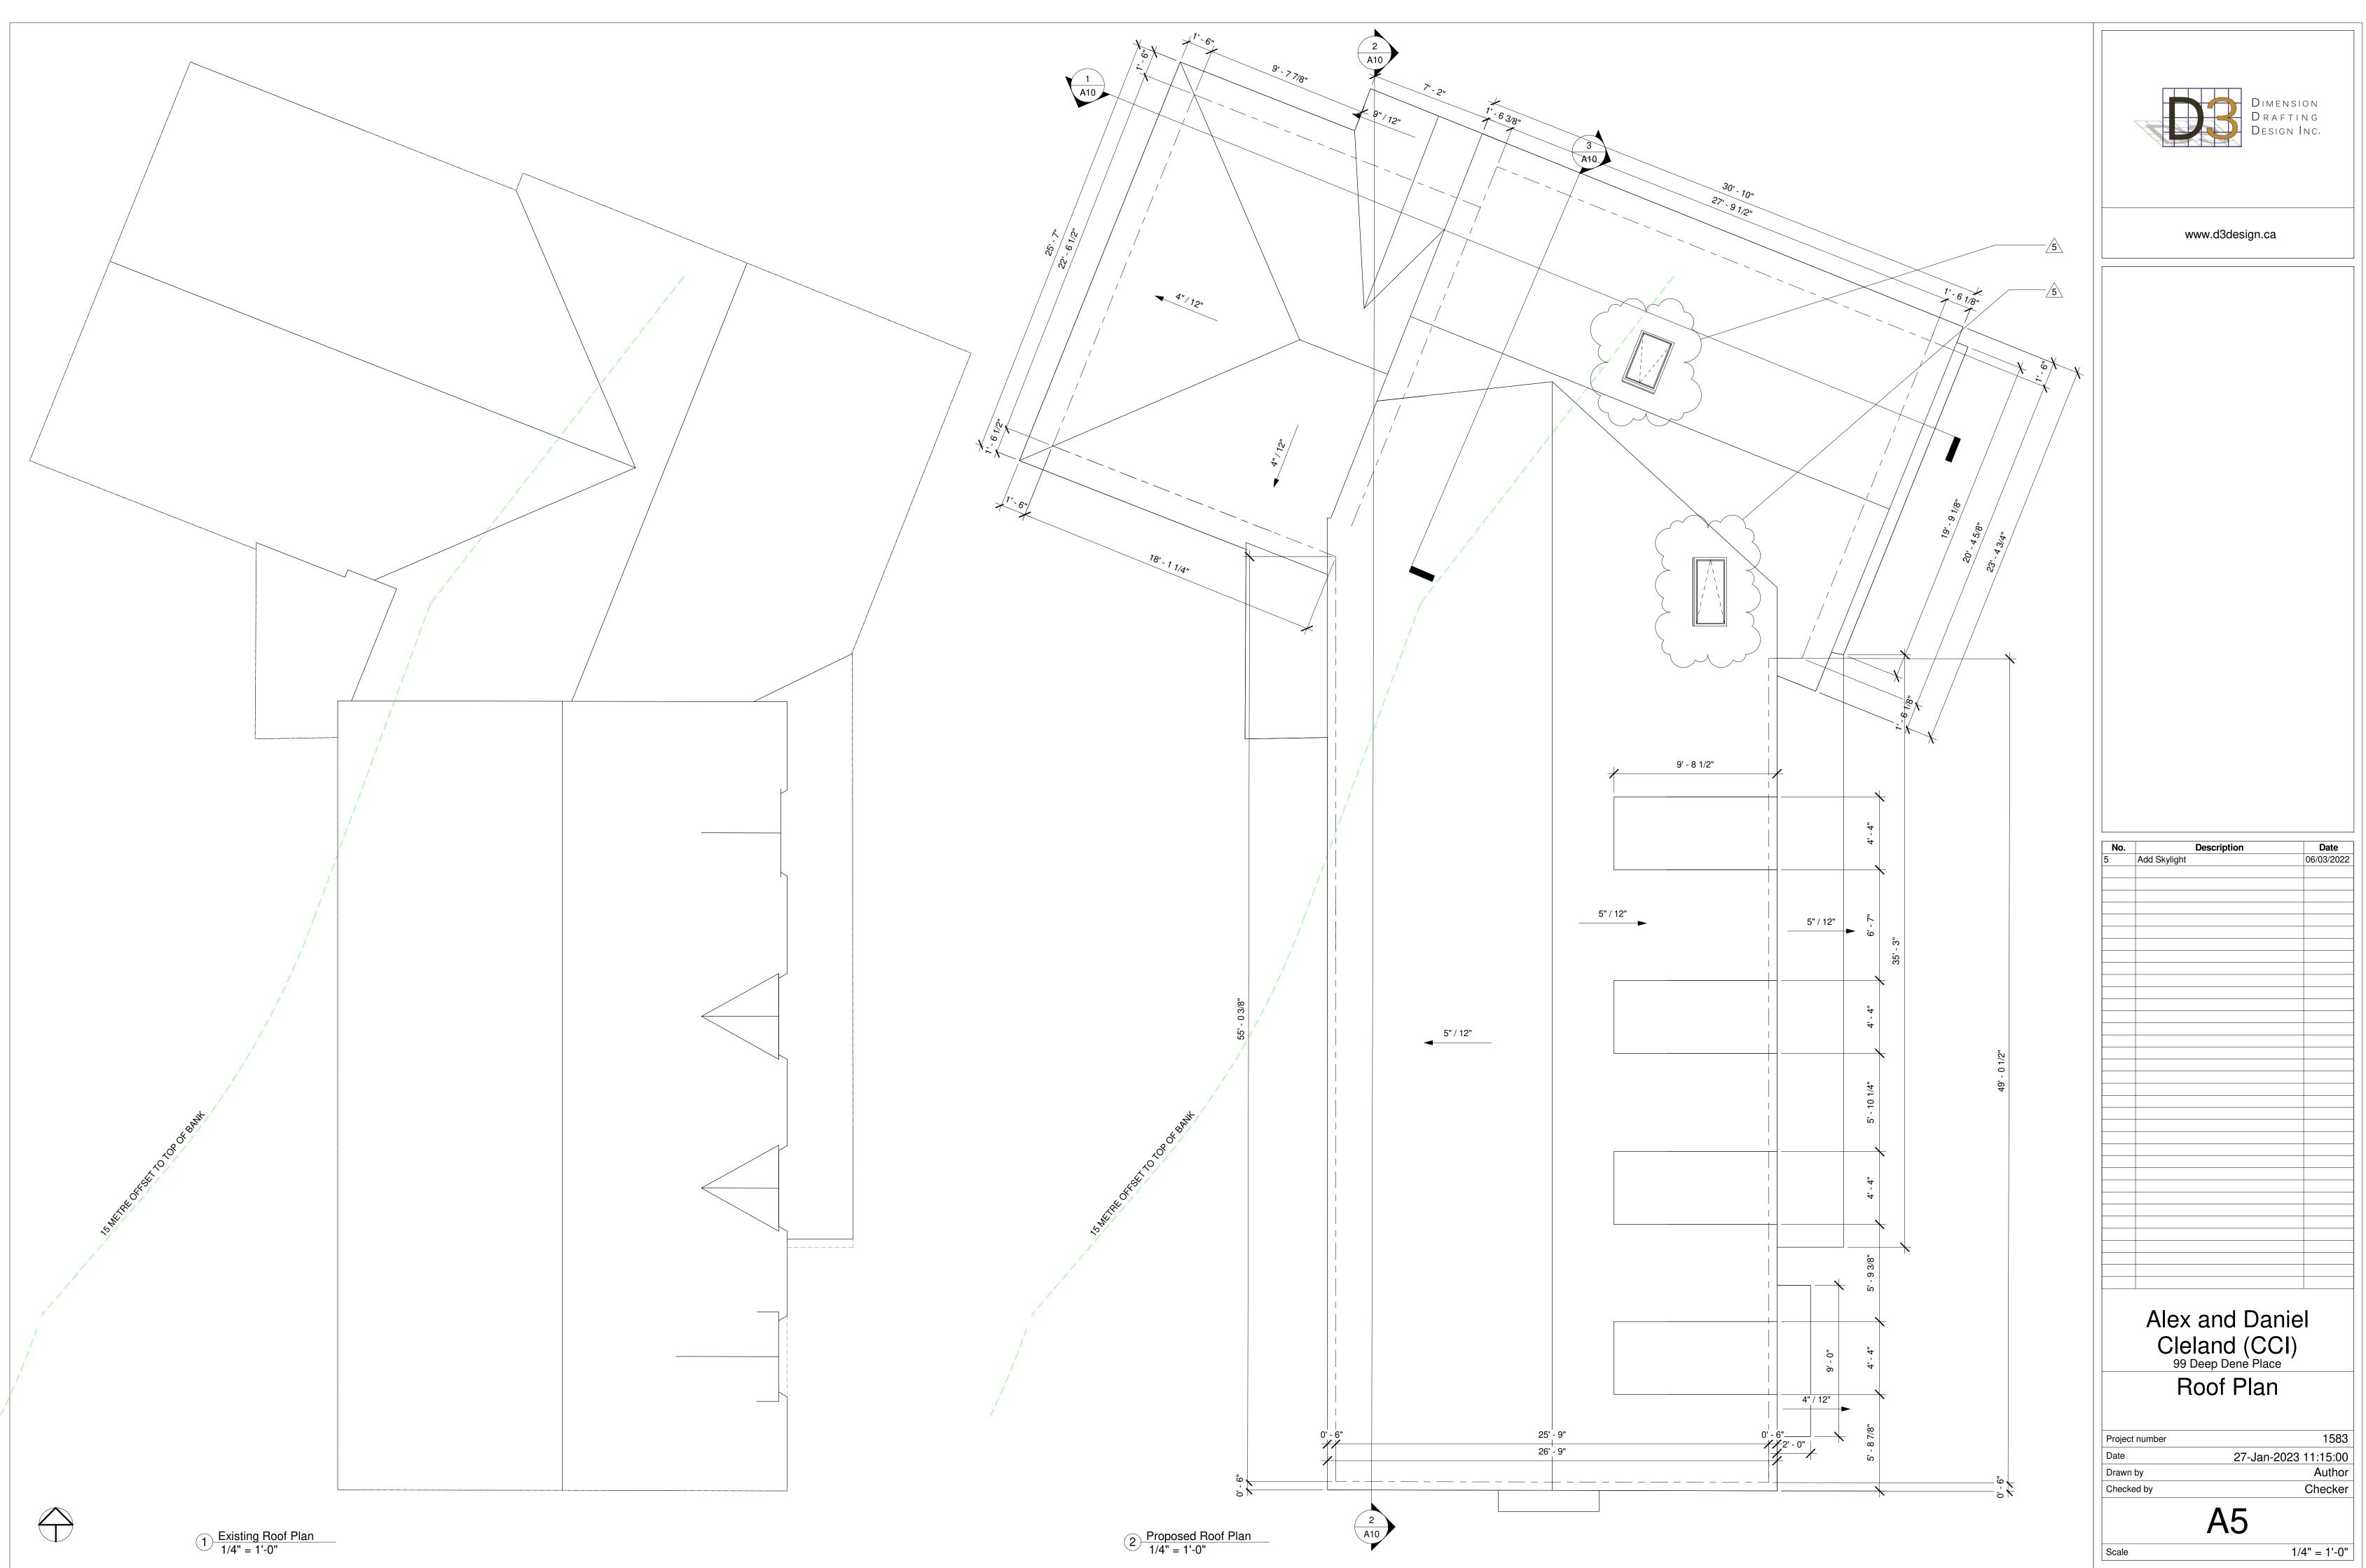

1 Existing Rear Elevation1/4" = 1'-0"

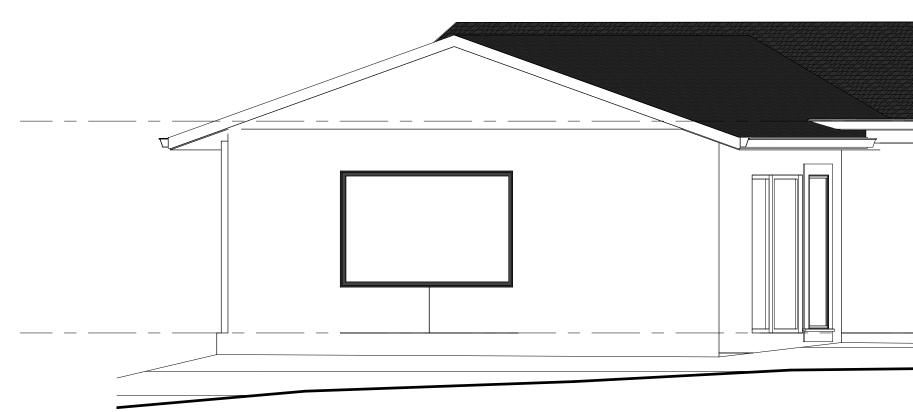

2 Rear Elevation 15m Zone 1/4" = 1'-0"

Basement No Changes


List of Changes within 15m Zone Main Floor

Upper Floor


New Siding
New Roofing
Existing Roof Alterations

New Walls
New Siding
New Windows
New Roof
Existing Roof Addition

Existing Roof Peak 626.60	DIMENSION DRAFTING DESIGN INC.
	www.d3design.ca
Existing Upper Floor 613.43	
Existing Main Floor 604.60	
<u>Existing Basement Floor</u> 595.77	
Roof Peak Max 628.26 Proposed Roof Peak 626.99	No. Description Date
Existing Upper Floor 613.43	
Existing Main Floor 604.60	
Existing Basement Floor 595.77	Alex and Daniel Cleland (CCI) 99 Deep Dene Place Critical 15m Area Elevations Project number 1583 Date 27-Jan-2023 11:15:00 Drawn by Author Checked by Checker A6 Scale 1/4" = 1'-0"

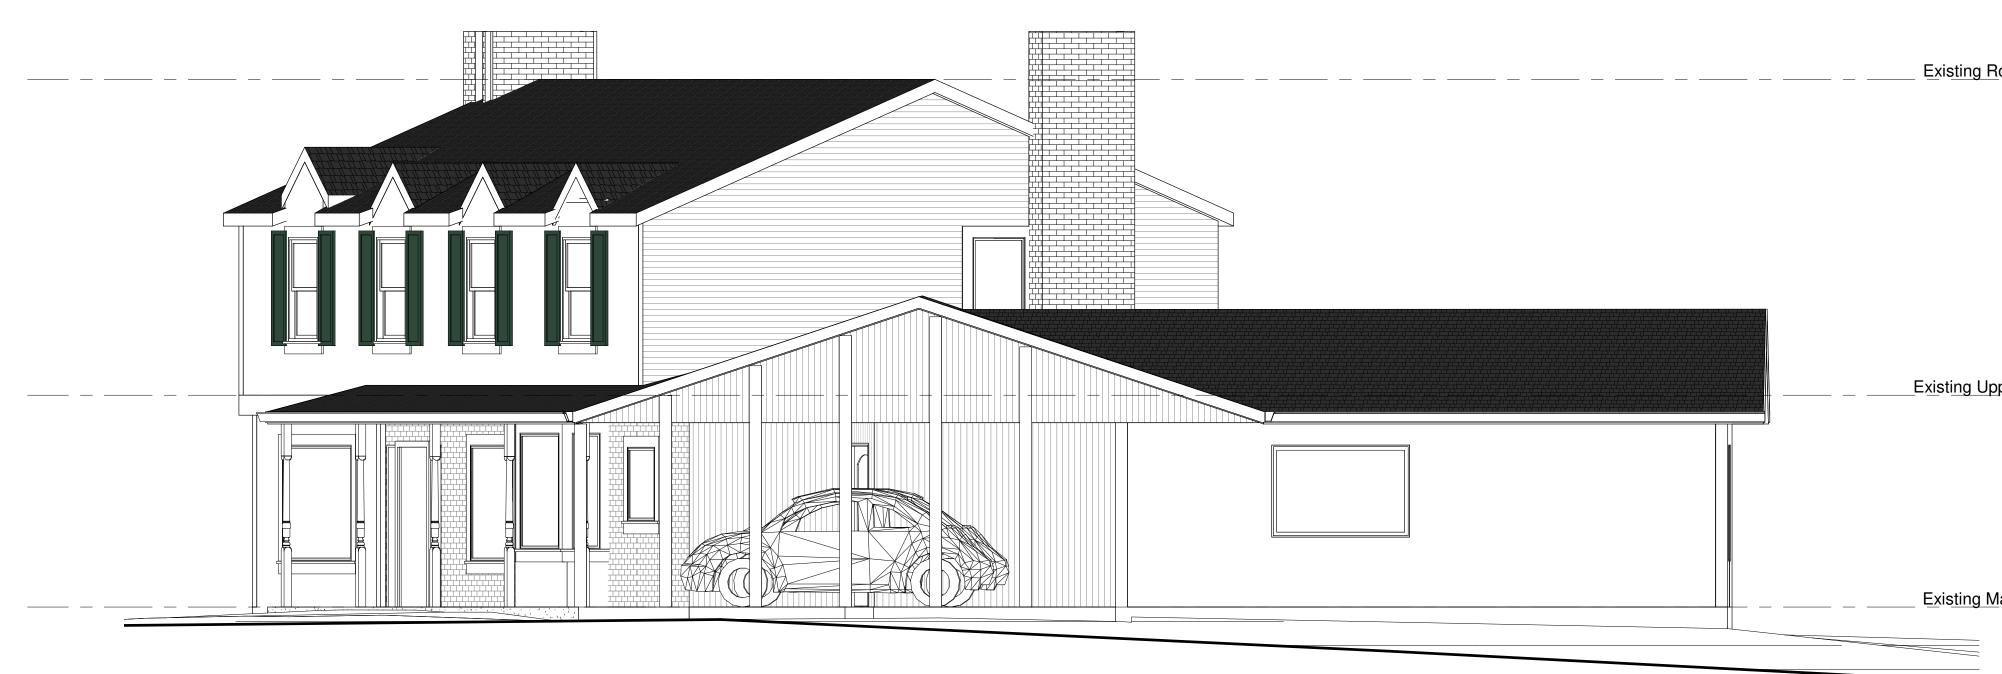

1 Existing Right Elevation 1/4" = 1'-0"

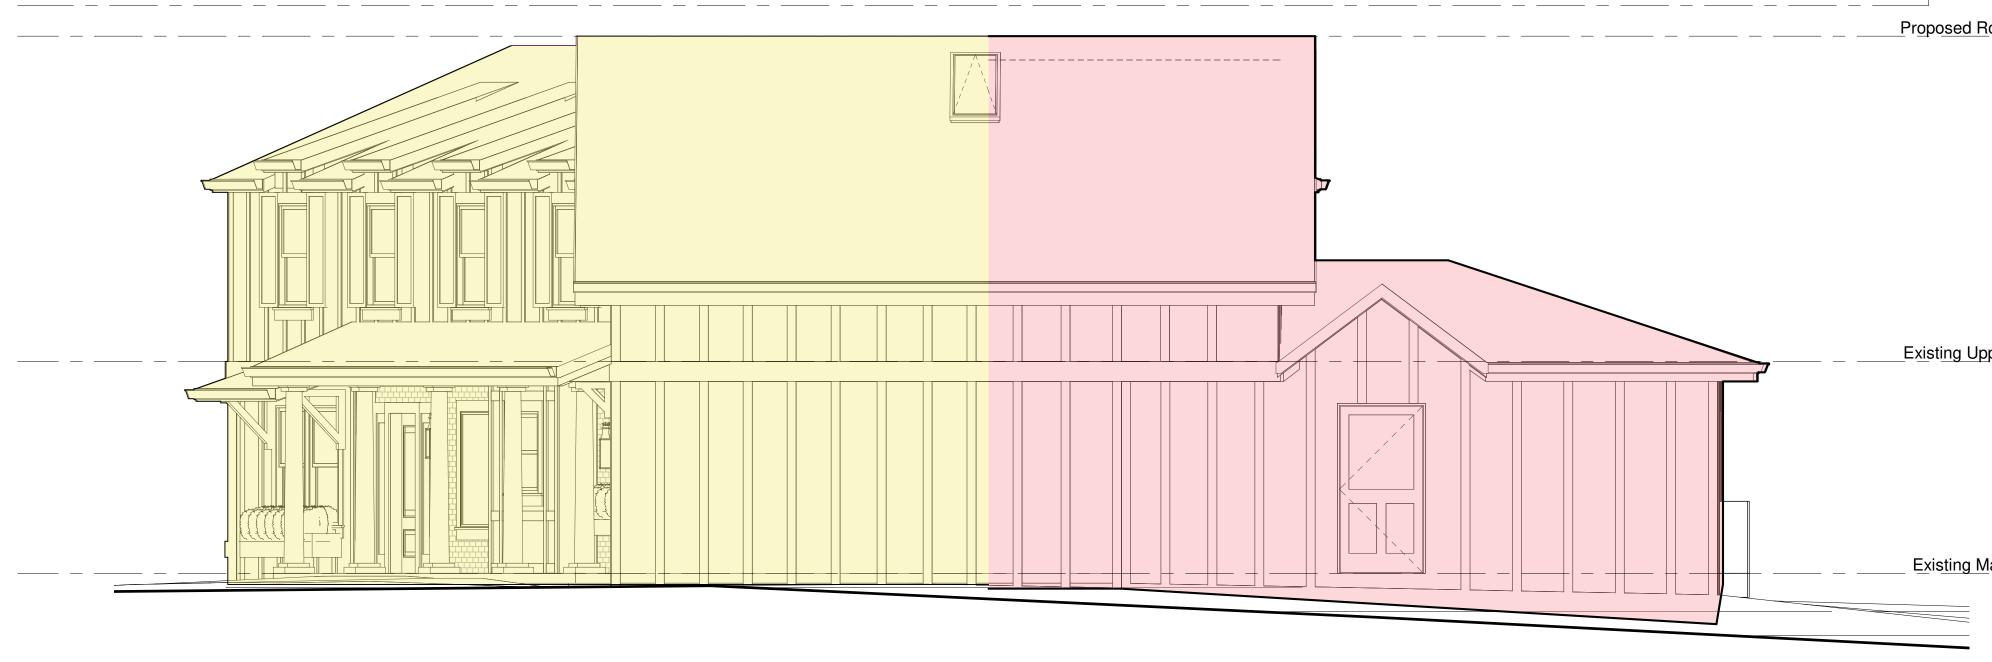

2 Right Elevation 15m Zone 1/4" = 1'-0"

List of Changes within 15m Zone List of Changes within 15m Zone Basement Main Floor No Changes

Existing Baseme

Roof P

Existing Baseme


Existing Roof Alterations
New Siding
New Door
New Stairs to Door


Upper Floor New RoofNew WallsNew Siding Area within 15m Line


Area not within 15m Line


Roof Peak 626.60	DIMENSION DRAFTING DESIGN INC.
	www.d3design.ca
oper F <u>loor</u> 613.43	
Main Floor 604.60	
nent Floor 595.77	
Peak Max 628.26 Roof Peak 626.99	
	No. Description Date
oper Floor 613.43	
<u>Main Floor</u> 604.60	
nent Floor 595.77	Alex and Daniel
ne	Cleland (CCI) 99 Deep Dene PlaceCritical 15m Area ElevationsProject number1583Date27-Jan-2023 11:15:01Drawn byAuthor
	Checked by Checker Author Checked by Checker A7 Scale 1/4" = 1'-0"



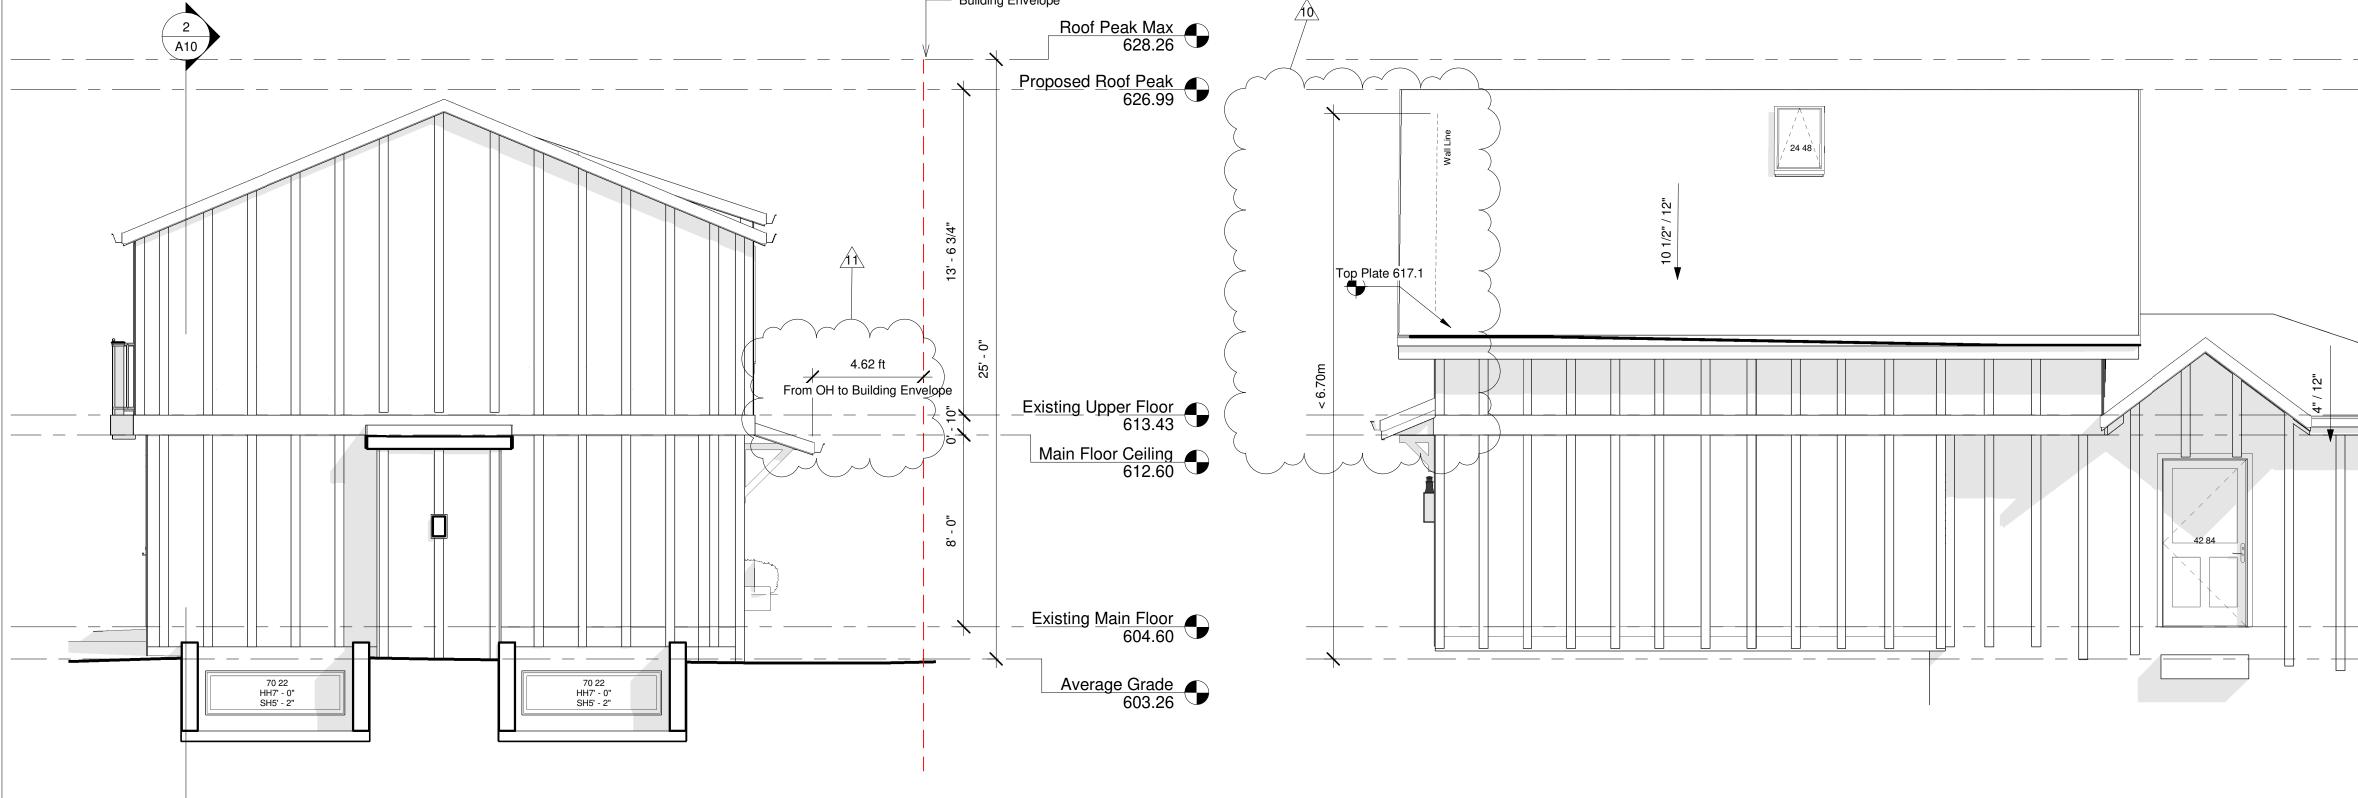


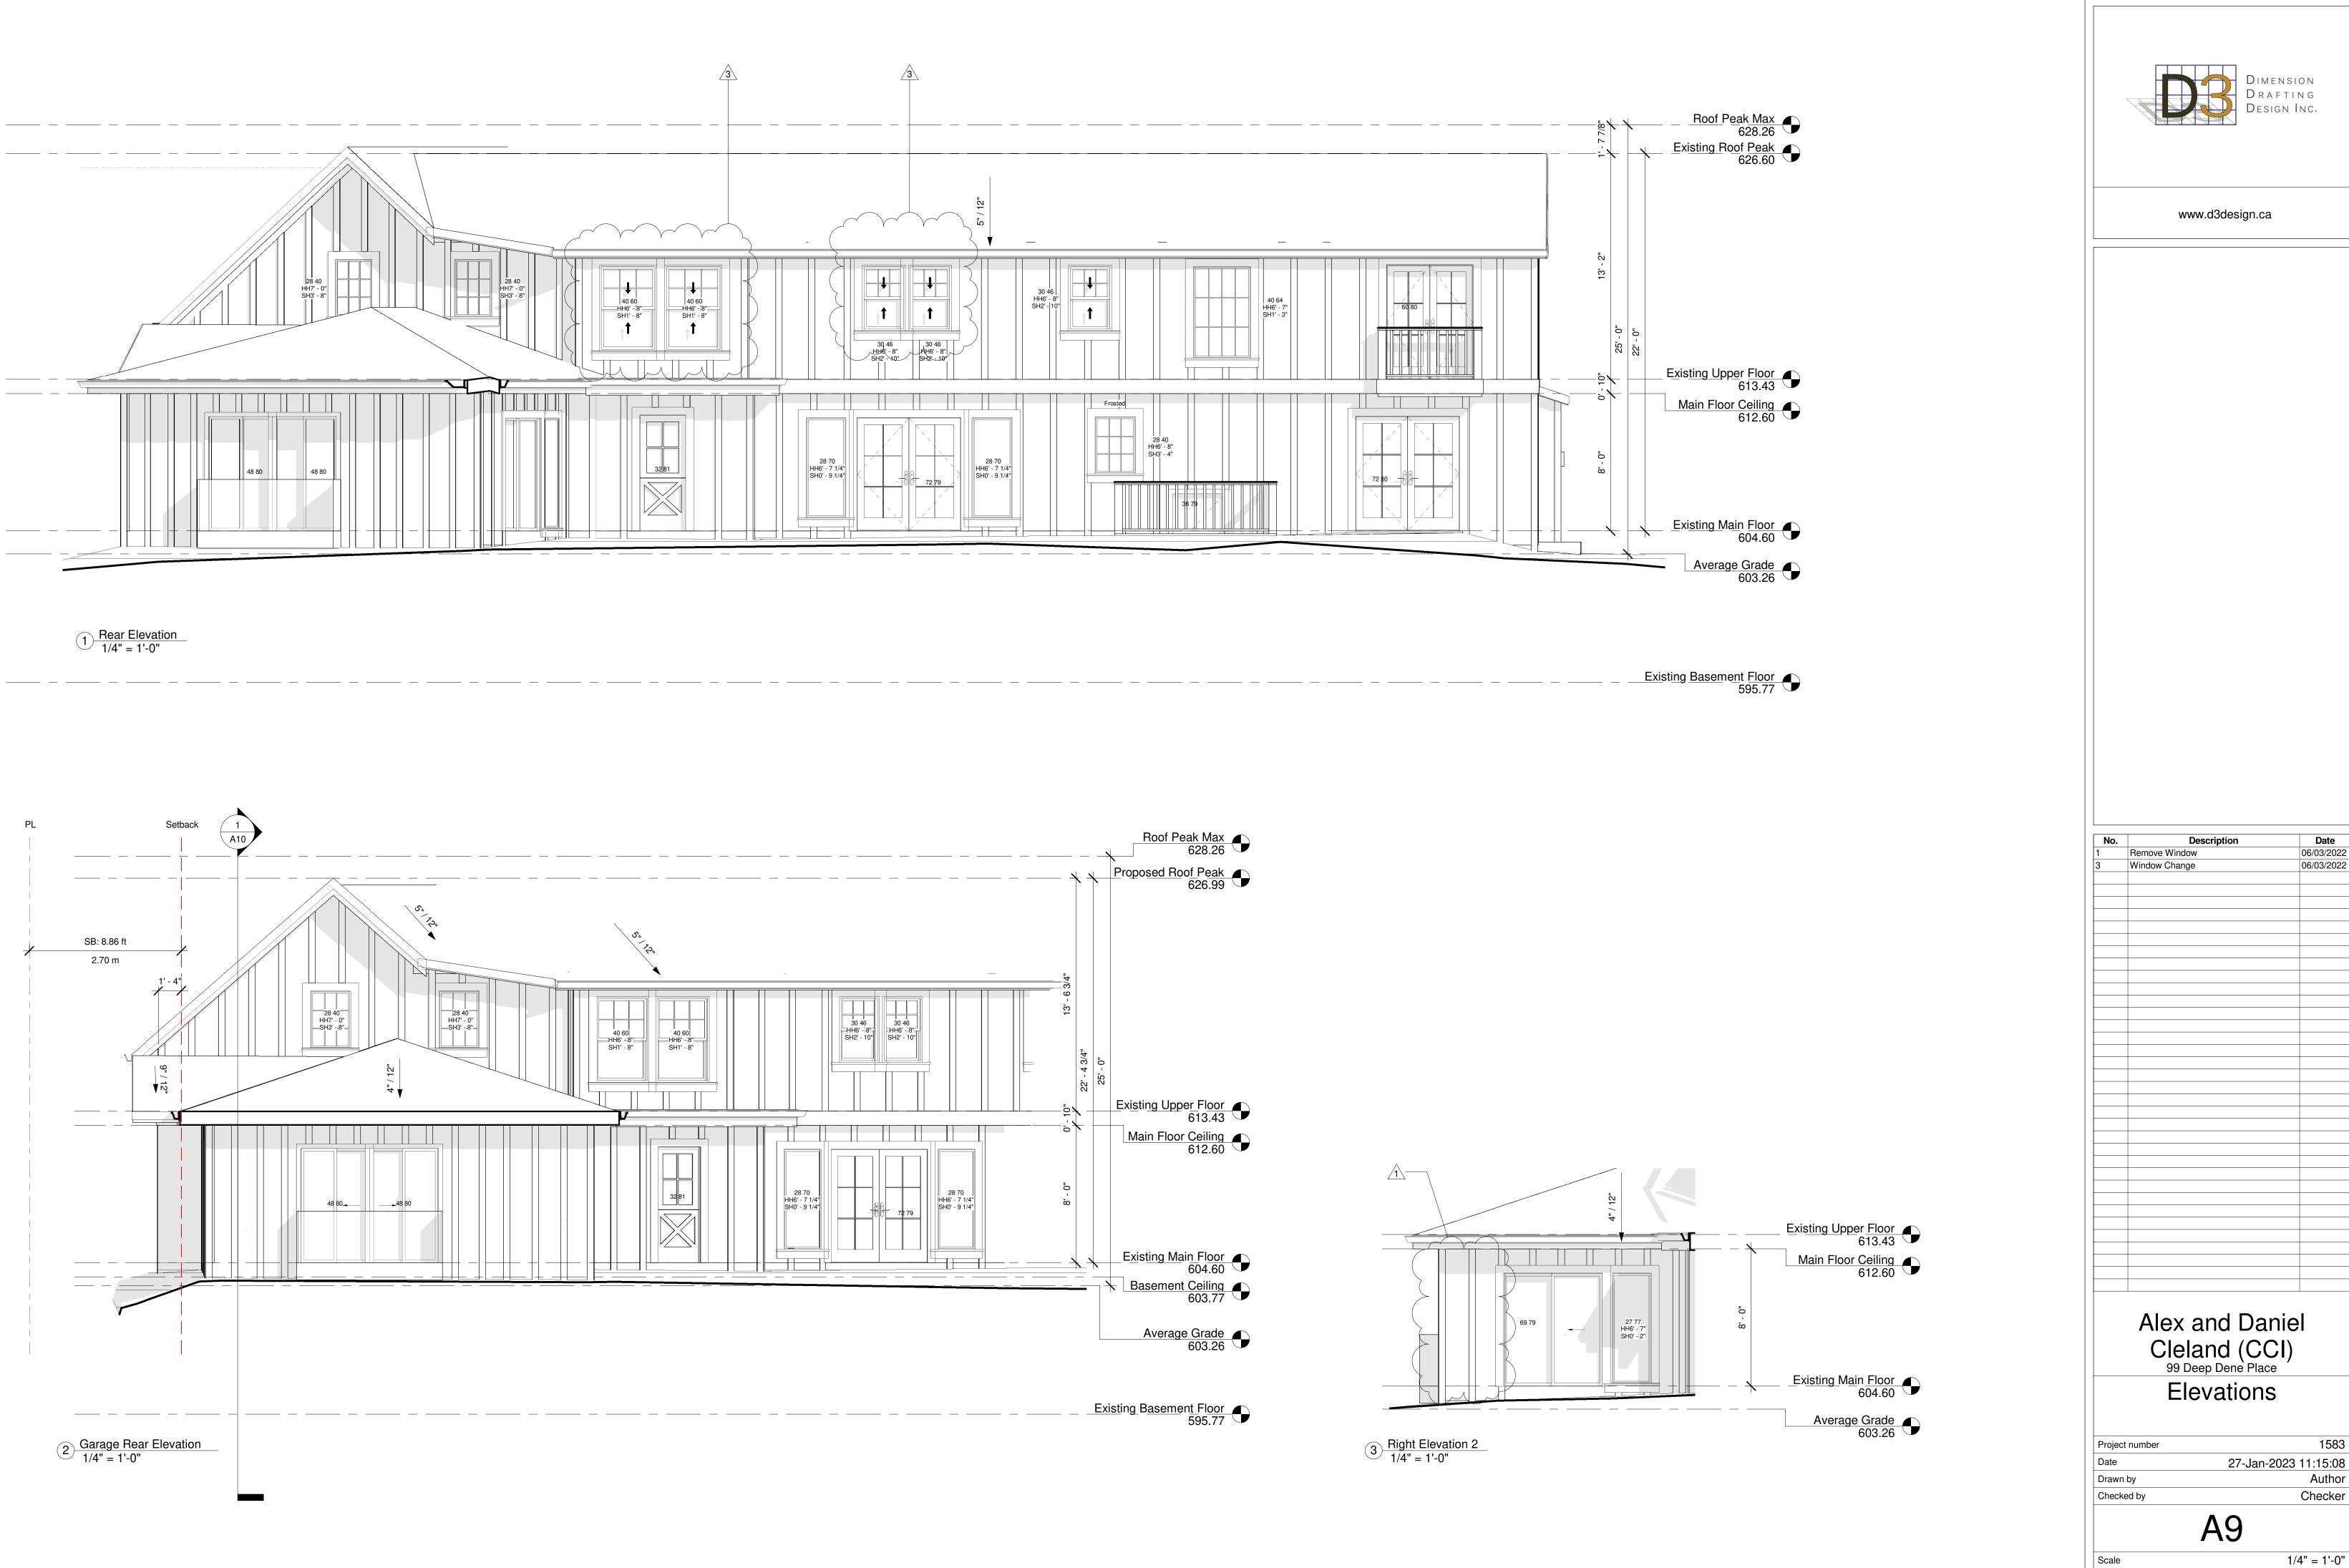


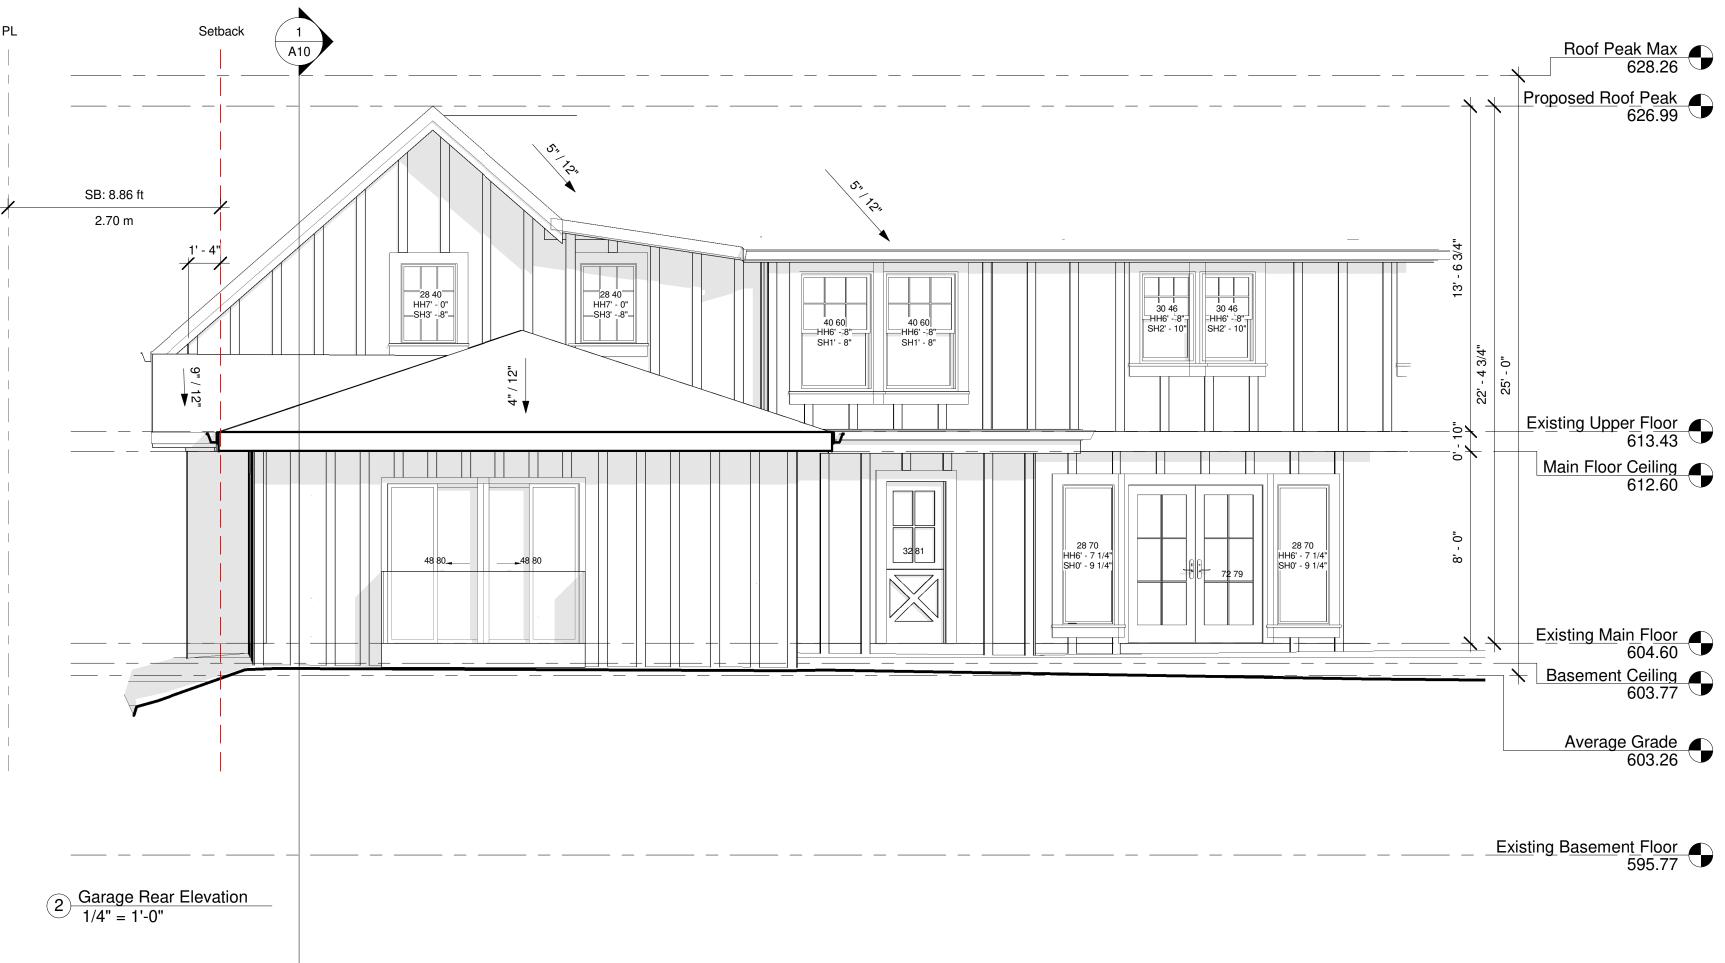

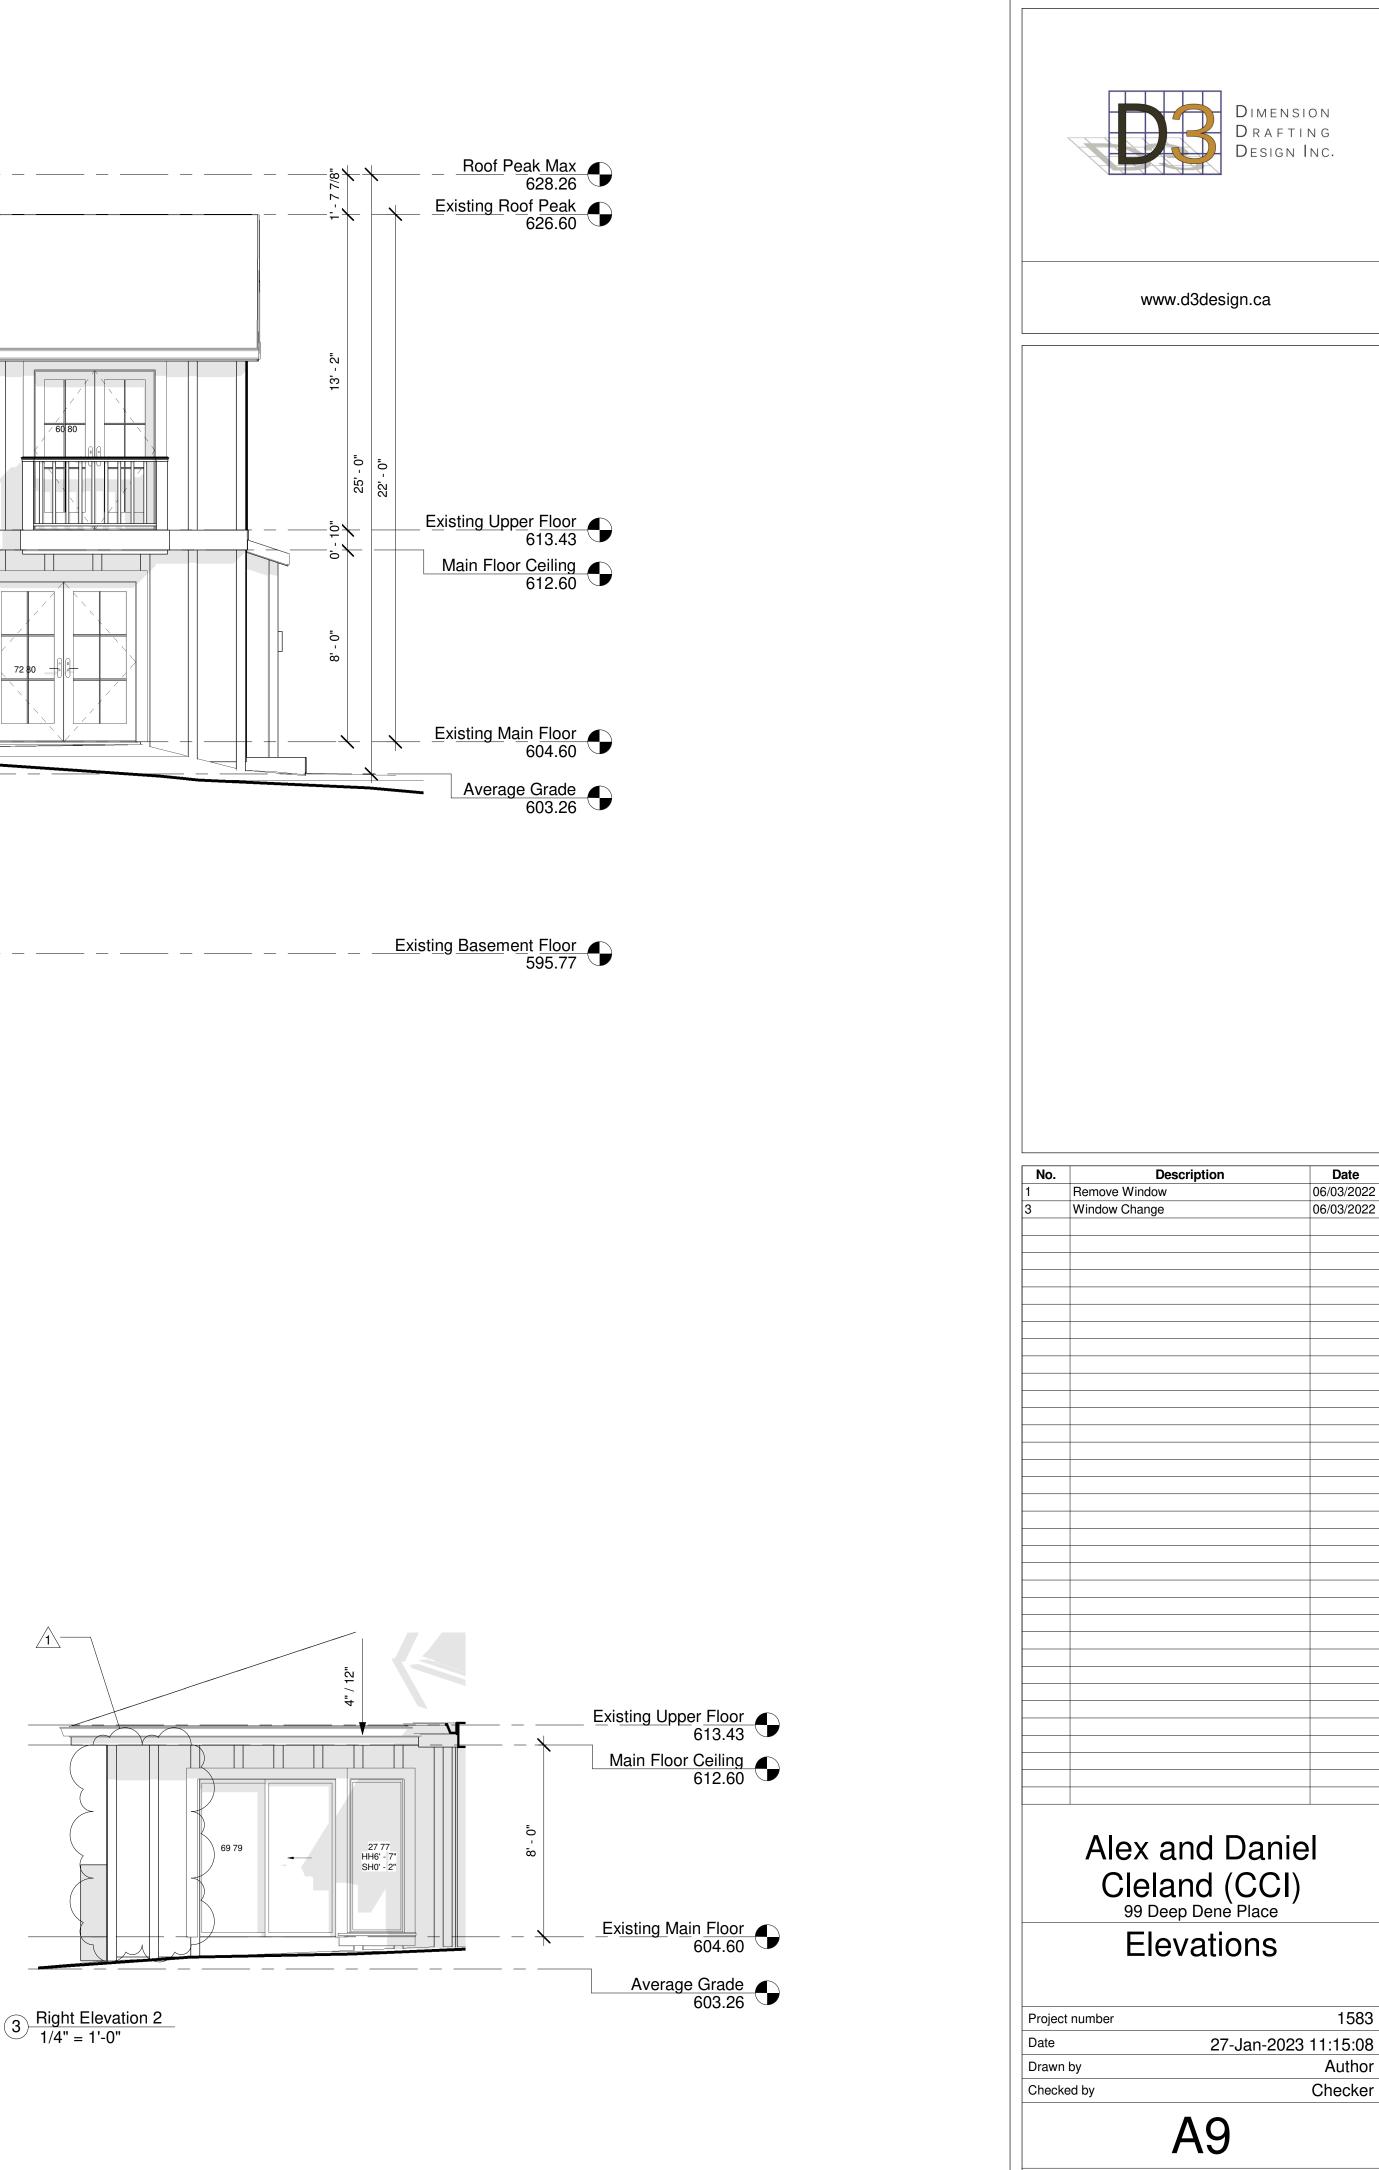

Scale

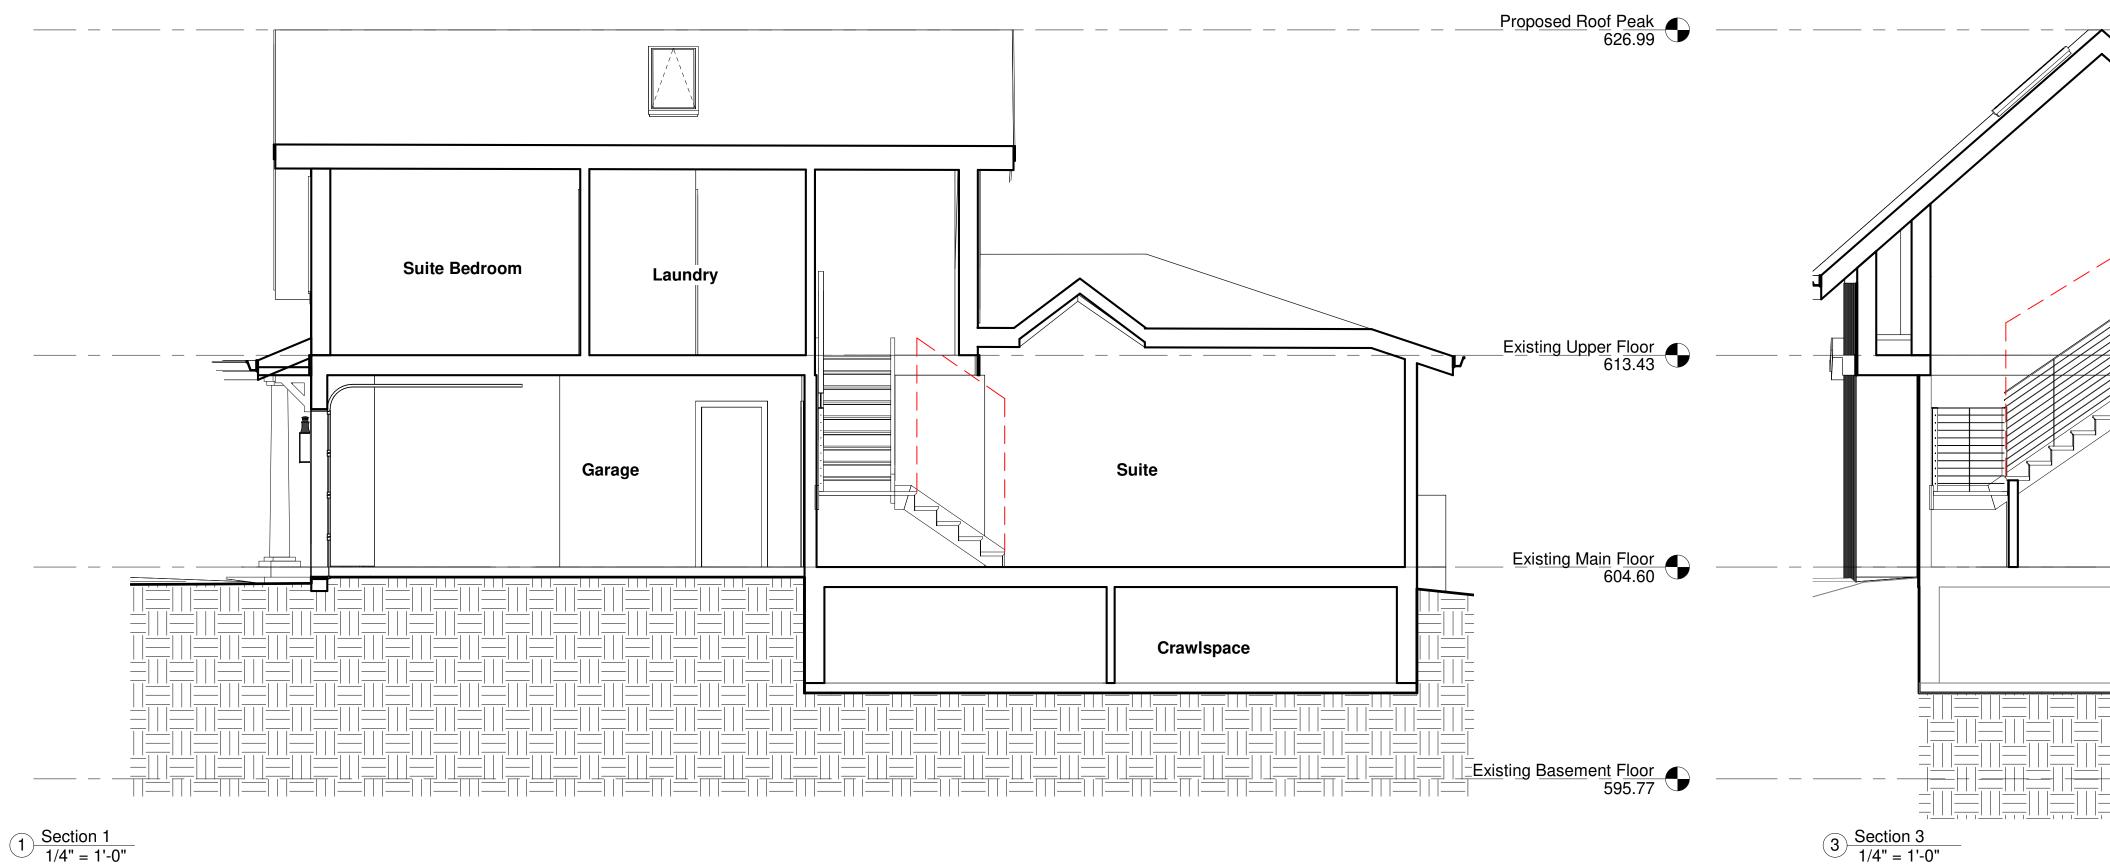

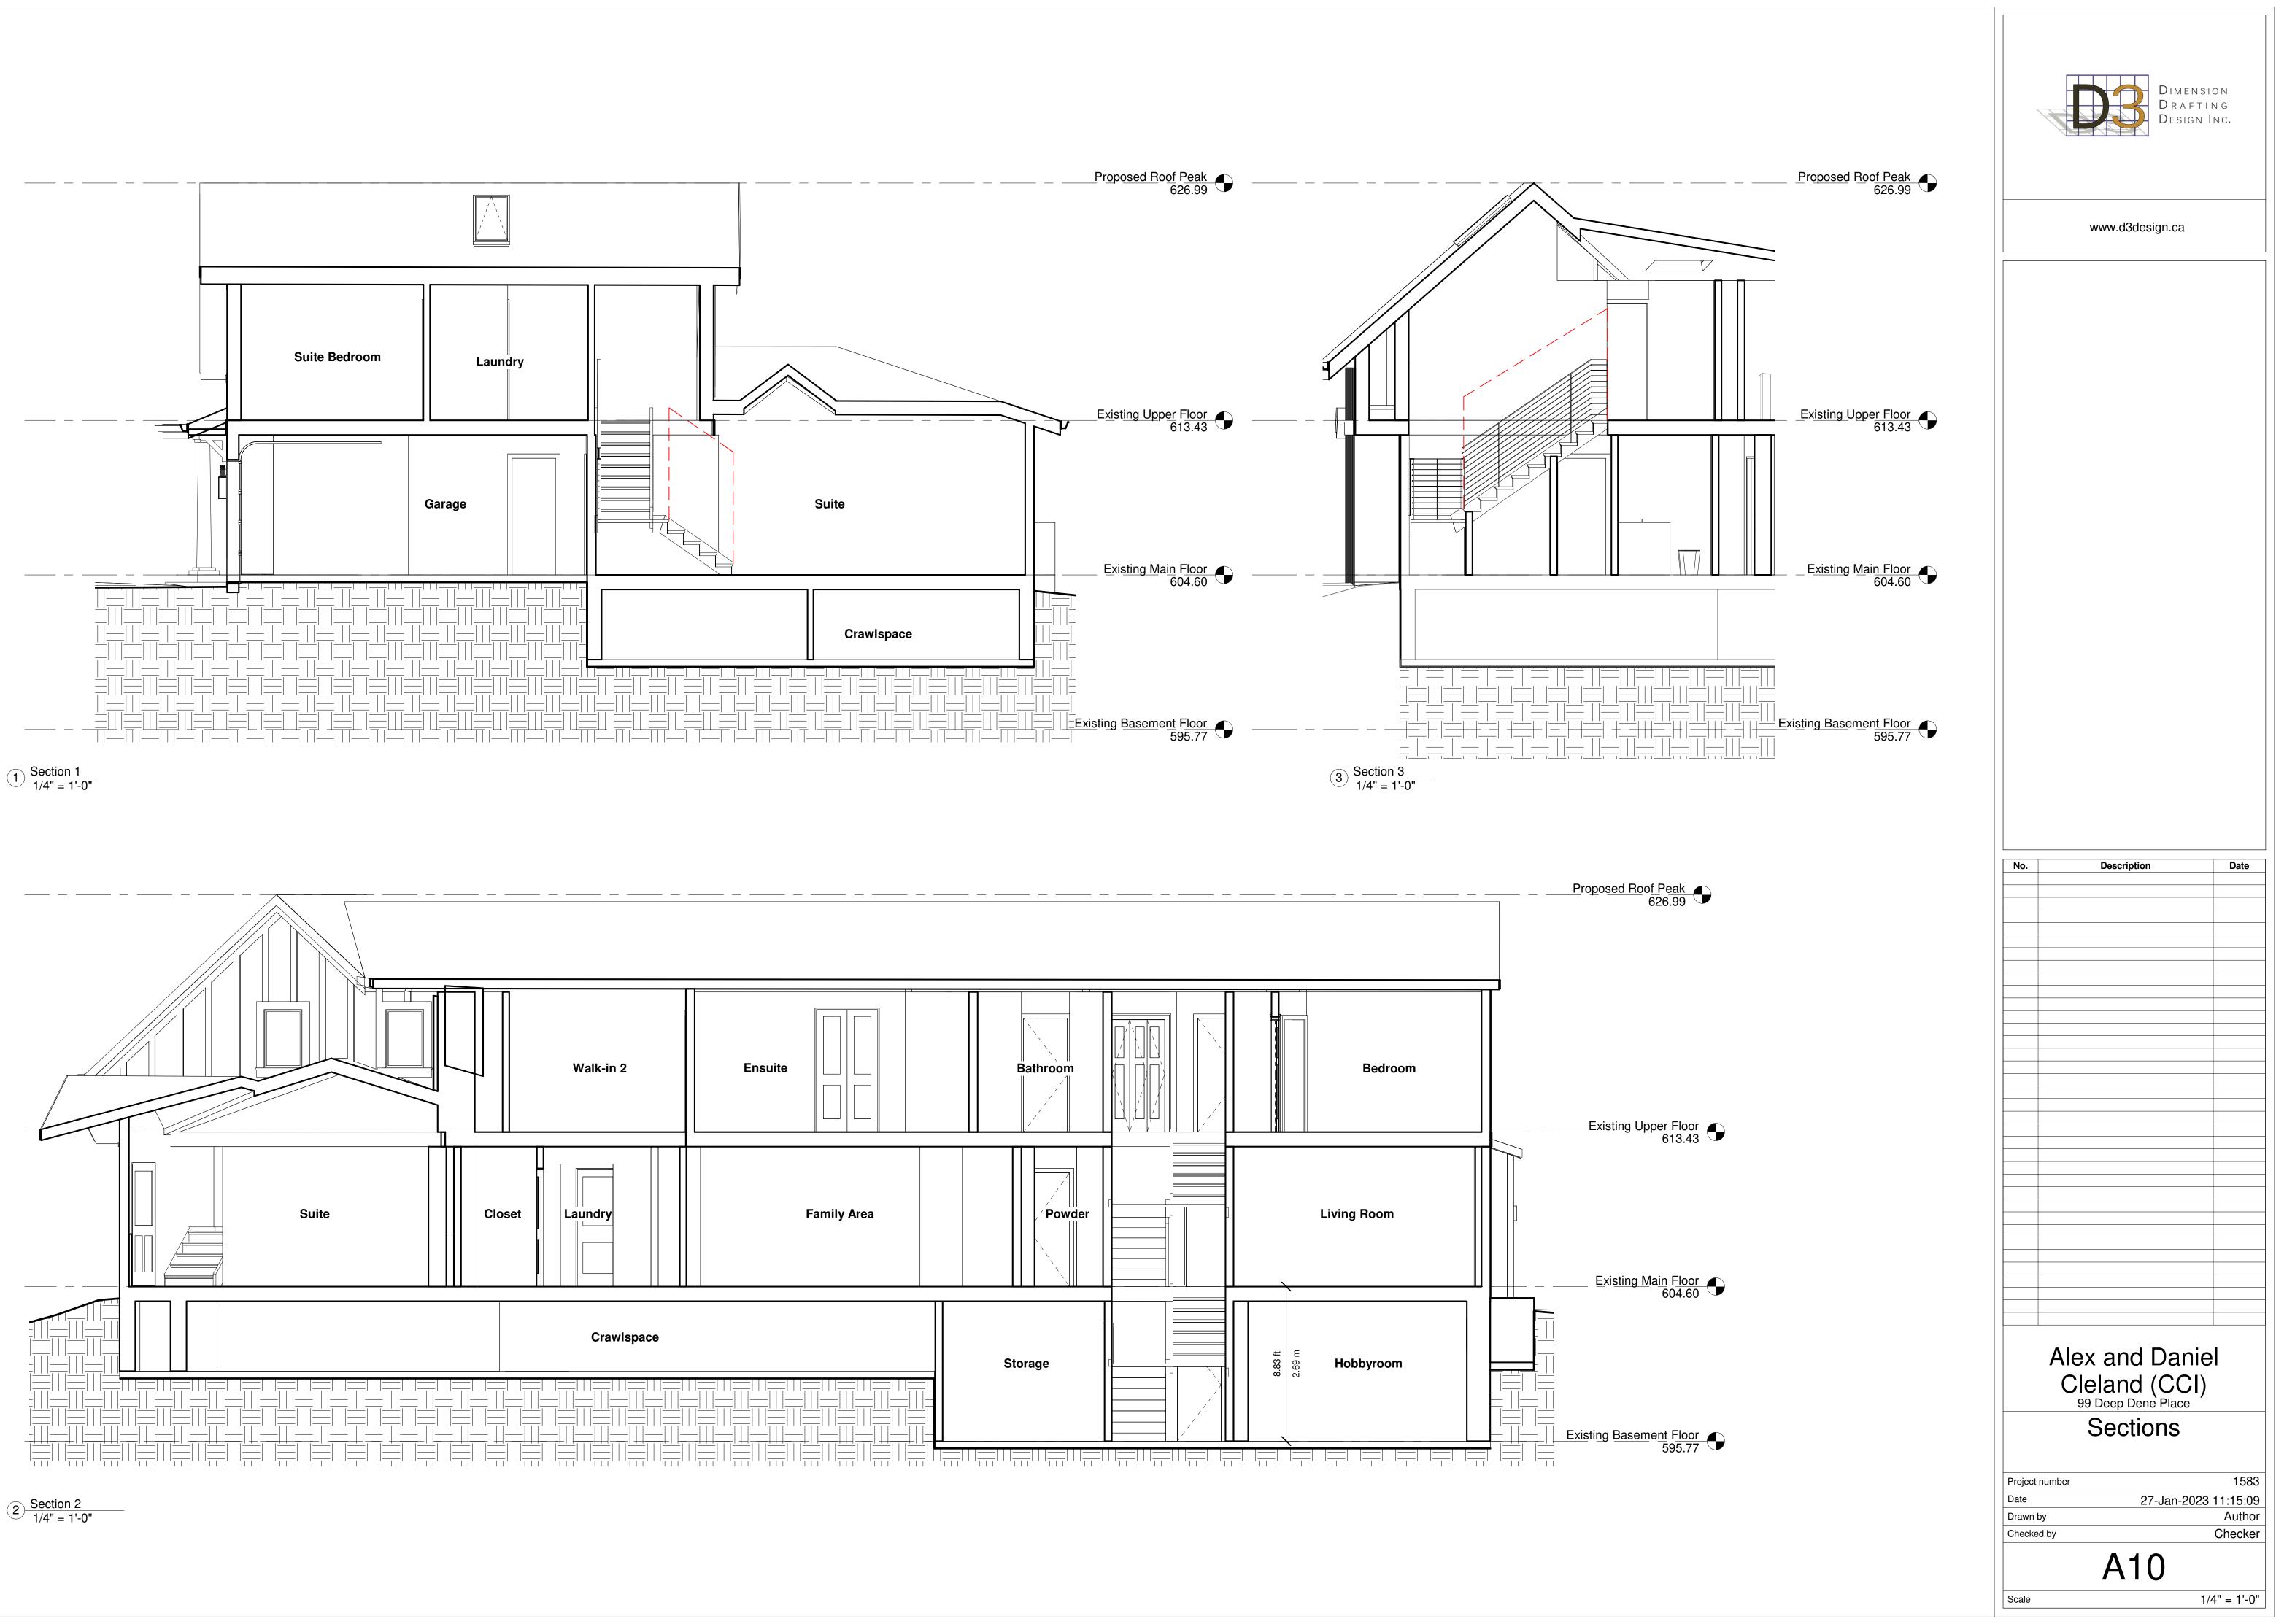







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Scale				6" = 1'-0"